MTROIKA

City of Kelowna January 20th, 2025 1435 Water Street, Kelowna BC, V1Y1J4

Barbara Crawford, Planner II

Troika Developments is a progressive, future-focused land and real estate development company based in Kelowna BC. Founded in 2000, Troika has built sustainable communities through the development, construction, and management of: 2,500 residential units, 300,000 square feet of commercial real estate, and 1,200 acres of land. We are involved from start to finish in the creation of living spaces and communities, from the acquisition of under-utilized land, construction, sales and marketing right through to property management.

Following several productive meetings and discussions regarding design parameters to meet the intent of the original Development Permit (DP) 23-0140, we are pleased to submit our revised Development Permit Application for the proposed development at 465 Dougall Road for your review and consideration.

We believe the submitted DP reflects our discussions and is suitable for staff-delegated approval, as per Development Procedures Policy – Schedule 4. The scope and scale of the variances are minor, the use and enjoyment of neighboring lands are comparable to the original DP, there are no new impacts on the natural environment, and the development maintains a consistent form and character appropriate for the area.

From the beginning, Troika has been about maximizing positive, local outcomes and building a legacy through the development of communities. We understand that the motivations of our community are essential to how we define project success, and are focused on creating value, success, and lasting impacts on the cities and towns that we operate in. As Kelowna is the city we call home, this community deserves the best outcomes possible. We believe that this project will serve our community and benefit the city through increasing housing availability for citizens. Whether it's for sale condo, affordable rental, or lasting income generating rental properties, we strive for excellence in the execution of our business plans and believe we can create outcomes far beyond real estate.

Troika has demonstrated an ability to execute across Western Canada, with projects proposed or underway in Kelowna, Lake Country, Merritt, Prince George, Edmonton, Regina, and Winnipeg. Our experience working with municipalities in each location allow us to adapt our projects and quickly pivot when necessary to realize the best possible outcomes.

To assist with the required review. The following items are enclosed with the submission:

- 1. Cover Letter Troika Developments
- 2. Design Rationale Lime Architecture
- 3. DP Amendment Lime Architecture



Adding Dimension.



- a. Elevations, sections, form and character
- 4. Landscape Set EDA Landscape Design
- 5. Landscape Bonding Value EDA Landscape Design
- 6. Geotechnical Report Interior Testing Ltd.
- 7. Functional Servicing Report McElhanney Ltd.
 - a. Servicing Memo, Grading Plan, Servicing Plan
- 8. Offsite Cost Estimate McElhanney Ltd.
- 9. Onsite Cost Estimate McElhanney Ltd.
- 10. Topo Survey Runnalls Denby Surveying
- 11. Water Conservation Report EDA Landscape Design
- 12. Title Documents
- 13. Owners Authorization

Should you have any questions concerning this application, please feel free to contact our offices

to discuss. We appreciate the opportunity given to Troika Management Corp. to present this

DP for your consideration. We look forward to hearing from you in the near future.

Regards,

Troika Management Corp.

Brad Clifton Senior Development Manager | TROIKA MANAGEMENT CORP. bradc@troikagroup.ca | C: 250.258.0067

302-554 Leon Ave, Kelowna, BC V1Y 6J6





Transmittal Page 1 of 5

To: Barbara Crawford CC: Brad Clifton bcrawford@kelowna.ca bradc@troikagroup.ca

January 20, 2025

Re: Design Rationale for the Proposed Development of 465-495 Dougall Road N, Kelowna, BC (The Site)

Dear Barbara Crawford,

Further to submitted information pertaining to the rezoning associated with the proposed Development of 465-495 Dougall Road N in Kelowna to a UC4r Zone designation, and the Amendment of the current Development Permit, we offer the following Rationale for the project:

Located in the Rutland Urban Centre, this is the perfect location for families requiring close proximity to amenities such as grocery and retail stores, restaurants, schools, and parks. The site is located in a Transit Oriented Area, offering alternative modes of transit to support those who wish to commute by bus, while also supporting those who wish to bike or walk to nearby amenities.

The proposed rental zoning designation (UC4r) aligns with the City's policies to address housing needs by increasing the availability of purpose-built rental units. This approach contributes to the creation of diverse and attainable housing options, supporting long-term affordability and stability for residents. By prioritizing rental housing, the project responds directly to the City's objectives of fostering sustainable community growth and meeting the needs of a growing population.

The development provides convenient short-term bicycle parking adjacent to the entrance of the building off Dougall Road N, as well as long-term bicycle parking complete with a bike wash and repair station in the parkade below. Garbage & recycling has been provided in the southeast corner of the property off the parking lot. The entrance to the parking area will be provided via a drive aisle which will be accessed from Dougall Road N, with the parking area itself located behind the building to screen it from street view. The below-ground parkade will be accessed via a ramp in the southeast corner of the parking area. The development consists of (11) bachelor apartment units, (53) 1-bedroom apartment units, (33) 2-bedroom apartment units, & (9) 3-bedroom apartment units. The ground-floor units along Dougall Road N will have ground-oriented access from the sidewalk. The proposed building will be 6-storeys (21.0m) tall and will conform to all requirements of the UC4r zone; no variances are being requested.

While the development is in a Transit Oriented Area and is exempt from providing parking beyond what is required to meet accessibility standards, a functional number of stalls is being provided to ensure the development can meet the needs of its tenants. The development provides (13) visitor stalls located in the surface parking area, (2) of which are accessible stalls ((1) of which is van-accessible), and (86) parking stalls within the parkade, (1) of which is an accessible stall.

Matt Johnston, Architect AIBC, LEED AP



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Summary of Proposed Amendment

To accompany the proposed Development Permit Amendment associated with the above development, a summary of changes has been provided to rationalize the proposed design.

To enhance the overall functionality and feasibility of the project, minor design changes have been implemented with a focus on improving building efficiencies, constructability, accessibility, and Building Code compliance. These adjustments were carefully made to align with best practices in design and construction while minimizing impacts on the form and character of the building.

Our primary objective is to retain the building's architectural integrity and original design intent while ensuring that the changes result in a net benefit for both the client and the city. By optimizing layout configurations, refining construction details, and addressing accessibility requirements associated with ever-changing Building Code regulations, we see a net improvement to the building's usability, constructability, and operational performance.

The relevant design changes have been organized into the following categories:

- 1. Reallocation of Common Outdoor Amenity Space
- 2. Surface Parking and Ramp Improvements
- 3. Location of Garbage and Recycling
- 4. Addition of Ground-Floor Residential Units
- 5. Relocation of Short-Term Bicycle Parking
- 6. Adjustment to Northwest Corner for Transformer Right-of-Way
- 7. Provision of Parkade Ventilation

1. Reallocation of Common Outdoor Amenity Space

To enhance safety and usability, the outdoor amenity space previously located in the parking lot drive aisle has been removed. This adjustment addresses the inherent hazards of placing amenity space in a traffic zone. To ensure required Common Outdoor Amenity Space requirements are being met, additional amenity space has been provided on the level 6 rooftop patio instead. The rooftop patio offers a significantly more functional and inviting environment for residents to enjoy outdoor activities. Elevated and away from traffic, the space provides a secure and quiet area with improved ambiance and views. The relocation also maximizes the usability of the outdoor amenity area, offering a cohesive and comfortable gathering space while freeing up valuable space within the parking lot for vehicular circulation and parking efficiency. This change prioritizes resident safety, enhanced user experience, and an improvement to the overall quality of the project.

Matt Johnston, Architect AIBC, LEED AP



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2. Surface Parking and Ramp Improvements

Functionality and user safety have been improved by reconfiguring the surface parking layout to eliminate its previous encroachment over the parkade ramp. This change allows for an extended ramp design, significantly reducing the ramp's slope percentage. The result is a smoother, safer transition into the parkade, enhancing vehicular safety and accessibility. Additionally, the extended ramp ensures adequate head clearance to the slab above, further improving functionality and compliance with safety standards. We believe this adjustment represents a net benefit to the project by prioritizing user safety and optimizing the ramp's performance.

3. Location of Garbage and Recycling

To optimize site functionality and aesthetics, we propose replacing the previously designed garbage room with in-ground garbage and recycling bins. These bins offer a more space-efficient solution by utilizing below-grade installation, freeing up valuable surface area for other uses. Their sleek, low-profile design reduces the visual impact on the site, eliminating the need for extensive screening or enclosure structures typically required for traditional waste storage facilities. Operational efficiency has also been carefully considered in this design. The existing hammerhead turnaround in the parking lot has been designed to accommodate a crane truck, ensuring convenient access and egress for waste collection. This configuration allows the truck to maneuver efficiently when emptying the bins, minimizing disruption to the site. The convenient hammerhead turnaround allows trucks to turnaround on-site, allowing them to reintegrate seamlessly with traffic on Dougall Road N.

4. Addition of Ground-Floor Residential Units

Following the removal of the garbage room and relocation of long-term bicycle parking to the parkade, we have introduced four additional residential units on the main floor. The garbage room has been replaced with in-ground garbage and recycling bins, and the previous bicycle room layout was determined to be an inefficient use of the available floor area. By relocating and reconfiguring these spaces, we have optimized the ground-floor plan to prioritize residential density, aligning with project goals and community housing needs. To accommodate the additional units, we will utilize the rental-only zoning incentive to achieve the necessary Floor Area Ratio (FAR) increase. This approach supports the project's alignment with the City's policies encouraging increased housing availability within urban areas. The reallocation of space not only ensures a more economical and functional ground-floor layout but also enhances the building's contribution to local housing stock.



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5. Relocation of Short-Term Bicycle Stalls

The short-term bicycle stalls have been relocated to the front entrance of the building to align with the City of Kelowna's bylaw requirements. This adjustment enhances compliance while improving convenience and visibility for cyclists. Positioning the stalls near the main entrance encourages active transportation by providing easily accessible and secure parking options in a prominent location. The placement also supports the building's integration into the broader urban mobility network, aligning with city goals to promote sustainable transportation alternatives. This relocation represents a thoughtful response to regulatory requirements and user needs, ensuring functionality and accessibility for residents and visitors alike.

6. Adjustment to Northwest Corner for Transformer Right-of-Way

The northwest corner of the building has been adjusted to accommodate an increase in the transformer right-of-way size, necessitated by the anticipated electrical demands of the building. This modification ensures sufficient space for the transformer installation, meeting utility provider requirements and supporting the safe and efficient delivery of electrical service to the site. This adjustment was carefully designed to maintain the form and character of the building while prioritizing compliance with technical and regulatory standards.

7. Provision for Parkade Ventilation

To meet safety and performance standards, mechanical ventilation will be incorporated into the parkade design. While the specific details will be finalized in collaboration with a mechanical engineer during the next phase of development, current planning anticipates the need for an intake air structure, likely a small "doghouse," positioned toward the southwest corner of the property. This intake air structure will facilitate adequate airflow to maintain air quality within the enclosed parkade and comply with applicable building codes and regulations.



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In summary, the rationale for this project is as follows:

- i. Provide an increase in density to a neighbourhood where this density is desired.
- ii. Provide a mix of unit types, from bachelor to 3-bed units (including ground-oriented).
- iii. The proposed development meets all City of Kelowna Bylaw requirements.

This proposed development recognizes the City of Kelowna's strategic approach to overall growth including better use of precious developable land in accordance with the City's OCP/Future Land Use, Healthy City Strategy and planning initiatives.

We look forward to your supportive comments in response to this Development Permit Amendment application.

Please do not hesitate to contact our office if you have any questions or require additional information in these matters.

Sincerely:

Matt Johnston // Architect AIBC, LEED AP LIME Architecture Inc.

Matt Johnston, Architect AIBC, LEED AP

<u>465-495 DOUGALL ROAD N, KELOWNA, BC</u>



PROPERTY DESCRIPTION

CIVIC: 465-495 DOUGALL RD N, KELOWNA, BC LEGAL: LOT A, PLAN EPP125056

<u>CONSULTANT TEAM</u>

<u>OWNER/ OPERATOR</u>

Troika Development 302-554 Leon Avenue Kelowna, BC V1Y 6J6 250-869-4945

Contact(s): Brad Clifton

ARCHITECTURAL

LIME Architecture 205-1626 Richter Street Kelowna, BC V1Y 2M3 250-448-7801

Contact(s): Brandon Dobroskay <u>CIVIL</u>

McElhanney 2281 Hunter Road Kelowna, BC V1X 7C5 250-861-8783


Contact(s): Jesse Granberg

		AKUF	<u> </u>
	LANDSCAPING	A-000	COVER SHEET
		A-001	SITE & PROJECT INFORMATION
	Al-Terra Group Ltd.	A-002	AREAS SCHEDULE
25	5307-47 Street NW Edmonton, AB T6B 3T4	A-101	PARKADE PLAN
	780-440-4411	A-102	LEVEL 1 PLAN
		A-103	LEVEL 2-5 PLAN
	Contact(s):	A-107	LEVEL 6 PLAN
	Will Packolyk	A-108	ROOF PLAN
		A-200	WEST ELEVATIONS

FOR DP

A-201	NORTH ELEVATIONS
A-202	EAST ELEVATIONS
A-203	South elevations
A-300	SECTIONS
A-400	Renderings
A-401	Renderings
A-402	Renderings
A-403	Renderings

ARCHITECTURAL SHEET LIST

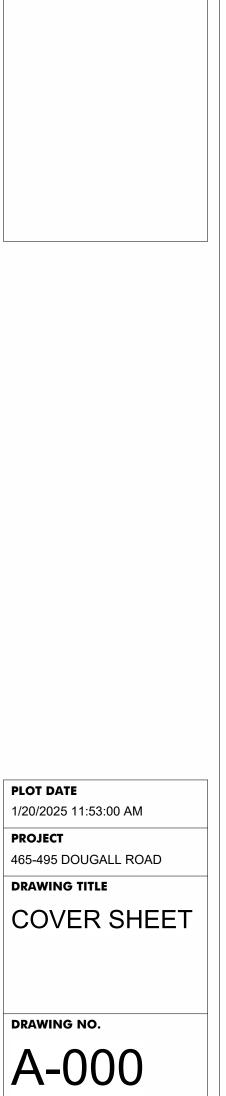

REVISION NO., DATE AND DESCRIPTION

01.13.25 FOR REVIEW 01.17.25 FOR REVIEW 01.20.25 FOR DP

as the british columbia building code revisions and addenda. All trades shall and protection of all under and above ground utilities, wires and conduit connections, including (but not limited to) water, sewer, gas, hydro and telephone.

immediately to LIME Architecture Inc. Do not Scale any dimensions from this drawing. All trades are to execute the work in accordance with the current municipality building by-laws and requirements of other local authorities having jurisdiction as well (most recent edition) including all published assume full responsiblity for the locations



PHONE:250-448-7801

205-1626 Richter Street, Kelowna, BC V1Y 2M3 www.limearchitecture.com

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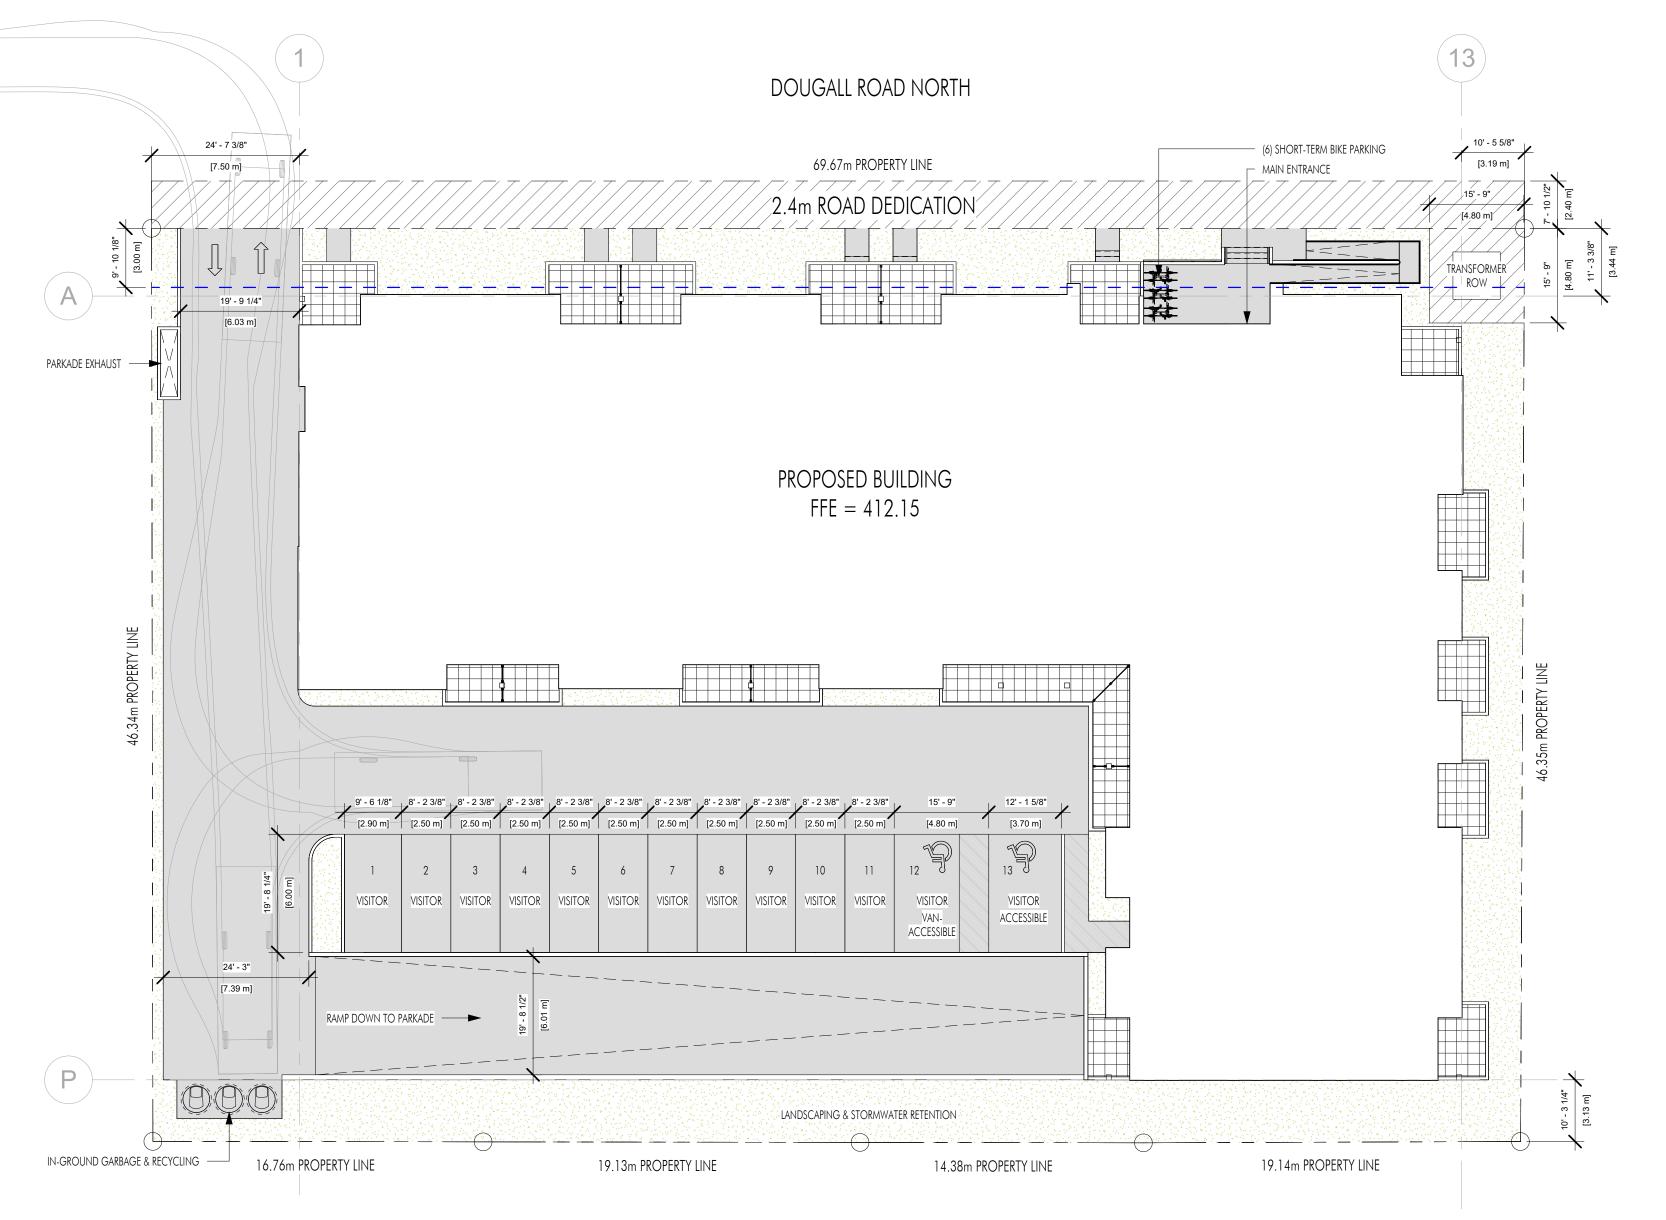
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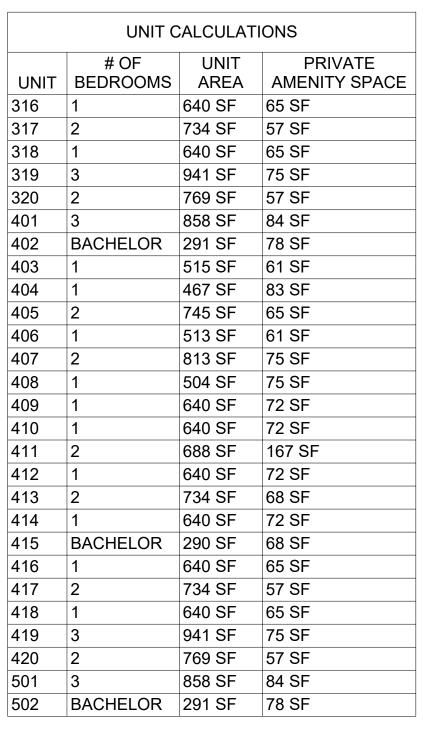
<u>465-495 DOUGALL ROAD NORTH, KELOWNA, BC</u>

PROPERTY DESCRIPTION:		
CIVIC: 465-495 DOUGALL ROAD NORTH, EGAL: LOT A, PLAN EPP125056	KELOWNA, BC	
<u>CONING CALCULATIONS:</u>		
CURRENT: CITY OF KELOWNA UC4 ZONI URBAN CENTRE ROPOSED: UC4	NG	
SITE INFORMATION:		
GROSS SITE AREA =	34,715 SF (3,225 m ²)	
SITE COVERAGE = SITE COVERAGE + HARDSCAPING = SAR + BONUS DENSITY =	<u>ALLOWED/REQUIRED</u> 85% (29,508 SF) 90% (31,244 SF) 1.8 + 0.3 = 2.1 FAR (72,902 SF)	<u>PROPOSED</u> 44% (15,428 SF) 85% (29,597 SF) 1.91 FAR (66,313 SF)
IEIGHT =	22.0 m (6 STOREYS)	21.0 m (6 STOREYS)
RIVATE & COMMON AMENITY SPACE: ACHELOR UNITS = BEDROOM UNITS = 2+ BEDROOM UNITS = OTAL	$6 m^{2}/UNIT x 11 UNITS = 66 m^{2} (710 SF)$ $10 m^{2}/UNIT x 53 UNITS = 530 m^{2} (5,705)$ $15 m^{2}/UNIT x 42 UNITS = 630 m^{2} (6,781)$ $1,226 m^{2} (13,197 SF)$	1
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REFER TO 'UNIT CALCULATIONS' TABLE F	OR BREAKDOWN OF PRIVATE AMENITY SPAC	E PER UNIT.
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206 1 513 SF 61 SF	204	1	467 SF	83 SF							
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207 2 813 SF 75 SF	206	1	513 SF	61 SF							
	207	2	813 SF	75 SF							
208 1 504 SF 75 SF	208	1	504 SF	75 SF							

	UNIT C	CALCULAT	IONS			
UNIT	# OF BEDROOMS	UNIT AREA	PRIVATE AMENITY SPACE		UNIT	BE
209	1	640 SF	72 SF		316	1
210	1	640 SF	72 SF		317	2
211	2	688 SF	167 SF		318	1
212	1	640 SF	72 SF		319	3
213	2	734 SF	68 SF		320	2
214	1	640 SF	72 SF		401	3
215	BACHELOR	290 SF	68 SF		402	BA
216	1	640 SF	65 SF		403	1
217	2	734 SF	57 SF		404	1
218	1	640 SF	65 SF		405	2
219	3	941 SF	75 SF		406	1
220	2	769 SF	57 SF		407	2
301	3	858 SF	84 SF		408	1
302	BACHELOR	291 SF	78 SF		409	1
303	1	515 SF	61 SF		410	1
304	1	467 SF	83 SF		411	2
305	2	745 SF	65 SF		412	1
306	1	513 SF	61 SF		413	2
307	2	813 SF	75 SF		414	1
308	1	504 SF	75 SF		415	BA
309	1	640 SF	72 SF		416	1
310	1	640 SF	72 SF		417	2
311	2	688 SF	167 SF		418	1
312	1	640 SF	72 SF	[419	3
313	2	734 SF	68 SF		420	2
314	1	640 SF	72 SF		501	3
315	BACHELOR	290 SF	68 SF	1	502	BA





UNIT CALCULATIONS										
	# OF	UNIT	PRIVATE							
UNIT	BEDROOMS	AREA	AMENITY SPACE							
503	1	515 SF	61 SF							
504	1	467 SF	83 SF							
505	2	745 SF	65 SF							
506	1	513 SF	61 SF							
507	2	813 SF	75 SF							
508	1	504 SF	75 SF							
509	1	640 SF	72 SF							
510	1	640 SF	72 SF							
511	2	688 SF	167 SF							
512	1	640 SF	72 SF							
513	2	734 SF	68 SF							
514	1	640 SF	72 SF							
515	BACHELOR	290 SF	68 SF							
516	1	640 SF	65 SF							
517	2	734 SF	57 SF							
518	1	640 SF	65 SF							
519	3	941 SF	75 SF							
520	2	769 SF	57 SF							
601	BACHELOR	291 SF	63 SF							
602	1	474 SF	162 SF							
603	1	467 SF	85 SF							
604	2	671 SF	99 SF							
605	1	512 SF	69 SF							
606	2	747 SF	694 SF							
607	1	427 SF	171 SF							
TOTAL	UNIT AREAS	66310 SF								



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REVISION NO., DATE AND DESCRIPTION

01.13.25 FOR REVIEW 01.17.25 FOR REVIEW 01.20.25 FOR DP

PROJECT

SITE &

DRAWING NO.

FOR DP

A-001

PROJECT

INFORMATION

465-495 DOUGALL ROAD **DRAWING TITLE**

PLOT DATE

1/20/2025 11:53:01 AM

	106		6,151.8 m²															
2								AREA SC	HEDULE									
	GROSS FLOOR AREA (EXTERIOR OF WALL)		GROSS FLOOR AREA		STORAGE (LEASABLE)		RESIDENTIAL (LEASABLE)							TOTAL (LEASABLE)		AMENITIES		
LEVEL	m2	ft2	m2	ft2	m2	ft2	BACHEL m ²	OR ft ²	1 BE m ²	D ft ²	2 BE m2	D ft2	3 BED m2) ft2	m2	ft2	m2	ft2
PARKADE																		
PARKADE	2,638.8 m²	28,404 ft²	2,582.0 m²	27,792 ft ²	0.0 m ²	0 ft²	0.0 m ²	0 ft²	0.0 m ²	0 ft²	0.0 m ²	0 ft²	0.0 m ²	0 ft²	0.0 m ²	0 ft²	0.0 m ²	0 ft²
	2,638.8 m ²	28,404 ft ²	2,582.0 m²	27,792 ft ²	0.0 m ²	0 ft ²	$0.0 \ m^2$	0 ft ²	$0.0 \ m^2$	0 ft ²	0.0 m ²	0 ft²	$0.0 \ m^2$	0 ft ²			0.0 m ²	0 ft²
LEVEL 1													70.0					
LEVEL 1	1,421.4 m ²	15,300 ft ²	1,383.6 m ²	14,893 ft ²	17.8 m ²	192 ft ²	54.0 m ²	581 ft ²	482.6 m ²	5,195 ft ²	489.5 m ²	5,269 ft ²	79.2 m ²	853 ft ²	1,123.2 m ²	12,090 ft²	162.7 m ²	1,751 ft ²
LEVEL 2	1,421.4 m ²	15,300 ft²	1,383.6 m ²	14,893 ft²	17.8 m ²	192 ft ²	54.0 m ²	581 ft²	482.6 m ²	5,195 ft ²	489.5 m ²	5,269 ft²	79.2 m ²	853 ft ²			162.7 m ²	1,751 ft²
LEVEL 2	1,426.5 m²	15,355 ft²	1,388.7 m ²	14,948 ft²	17.8 m ²	192 ft²	54.0 m ²	581 ft²	541.1 m ²	5,824 ft²	416.3 m ²	4,481 ft²	166.9 m²	1,797 ft ²	1,196.1 m²	12,875 ft²	138.6 m²	1,492 ft²
LEVEL 3	1,426.5 m ²	15,355 ft²	1,388.7 m²	14,948 ft²	17.8 m²	192 ft ²	54.0 m ²	581 ft ²	541.1 m ²	5,824 ft²	416.3 m ²	4,481 ft²	166.9 m²	1,797 ft²			138.6 m²	1,492 ft²
LEVEL 3	1,426.5 m ²	15,355 ft ²	1,388.7 m ²	14,948 ft ²	17.8 m ²	192 ft²	54.0 m ²	581 ft ²	541.1 m ²	5,824 ft ²	416.3 m ²	4,481 ft ²	166.9 m ²	1,797 ft 2	1,196.1 m ²	12,875 ft²	138.6 m ²	1,492 ft²
, I	1,426.5 m ²	15,355 ft ²	1,388.7 m ²	14,948 ft ²	17.8 m ²	192 ft ²	54.0 m ²	581 ft²	541.1 m ²	5,824 ft ²	416.3 m ²	4,481 ft²	166.9 m ²	1,797 ft 2	•	*	138.6 m ²	1,492 ft²
LEVEL 4	91	31	2	57						14		27		20				8
LEVEL 4	1,426.5 m²	15,355 ft ²	1,388.7 m ²	14,948 ft²	17.8 m ²	192 ft²	54.0 m²	581 ft²	541.1 m ²	5,824 ft²	416.3 m ²	4,481 ft²	166.9 m²	1,797 ft ²	1,196.1 m²	12,875 ft ²	138.6 m²	1,492 ft²
LEVEL 5	1,426.5 m ²	15,355 ft²	1,388.7 m ²	14,948 ft²	17.8 m²	192 ft ²	54.0 m ²	581 ft²	541.1 m ²	5,824 ft²	416.3 m ²	4,481 ft²	166.9 m²	1,797 ft ²			138.6 m²	1,492 ft²
LEVEL 5	1,426.5 m²	15,355 ft ²	1,388.7 m ²	14,948 ft²	17.8 m ²	192 ft ²	54.0 m ²	581 ft²	541.1 m ²	5,824 ft ²	416.3 m ²	4,481 ft²	166.9 m²	1,797 ft ²	1,196.1 m²	12,875 ft ²	138.6 m ²	1,492 ft²
	1,426.5 m ²	15,355 ft ²	1 <i>,</i> 388.7 m ²	14,948 ft²	17.8 m ²	192 ft ²	54.0 m ²	581 ft²	541.1 m ²	5,824 ft ²	416.3 m ²	4,481 ft²	166.9 m ²	1,797 ft²			138.6 m ²	1,492 ft²
LEVEL 6																		
LEVEL 6	599.8 m ²	6,456 ft²	579.4 m ²	6,237 ft ²	17.8 m ²	192 ft ²	26.9 m ²	290 ft ²	174.6 m ²	1,879 ft²	131.7 m ²	1,418 ft ²	0.0 m ²	0 ft²	351.1 m²	3,779 ft²	553.3 m²	5,956 ft²
ROOF	599.8 m ²	6,456 ft²	579.4 m ²	6,237 ft²	17.8 m ²	192 ft ²	26.9 m ²	290 ft ²	174.6 m ²	1,879 ft ²	131.7 m ²	1,418 ft²	0.0 m ²	0 ft ²			553.3 m^2	5,956 ft²
ROOF	32.2 m ²	347 ft ²	26.1 m ²	281 ft²	0.0 m ²	0 ft²	0.0 m ²	0 ft ²	0.0 m ²	0 ft²	0.0 m ²	O ft²	0.0 m ²	0 ft²	0.0 m ²	0 ft²	0.0 m ²	0 ft²
	32.2 m ²	347 ft ²	26.1 m ²	281 ft²	0.0 m ²	0 ft ²	0.0 m ²	0 ft ²	0.0 m ²	0 ft ²	0.0 m ²	0 ft ²	0.0 m ²	0 ft ²			0.0 m ²	0 ft ²
GRAND TOTAL	10,398.4 m ²	111,927 ft²	10,126.0 m ²	108,995 ft²	107.0 m ²	1,152 ft²	296.8 m ²	3,195 ft ²	2,821.5 m ²	30,370 ft²	2,286.4 m ²	24,611 ft²	747.0 m ²	8,041 ft ²	6,258.8 m²	67,369 ft²	1,270.4 m ²	13,675 ft²

*Unless otherwise noted, all areas are calculated to finished interior of exterior wall.

UNIT COUNTS

11

53

33

UNIT TYPE

BACHELOR

1 BED

2 BED

3 BED

UNIT COUNT AVERAGE AREA TOTAL AREA

27.0 m²

53.2 m²

69.3 m²

83.0 m²

296.8 m²

2,821.5 m²

2,286.4 m²

747.0 m²

FOR DP



AREAS SCHEDULE

DRAWING TITLE

465-495 DOUGALL ROAD
DRAWING TITLE


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	e to execute the work in with the current municipality
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building by- local authori as the british (most recent revisions and assume full n and protection ground utilitii connections, water, sewer REVISION AND DES 01.13.25	aws and requirements of other tites having jurisdiction as well columbia building code - edition) including all published d addenda. All trades shall responsibility for the locations on of all under and above es, wires and conduit including (but not limited to) ; gas, hydro and telephone. N NO., DATE SCRIPTION FOR REVIEW FOR REVIEW

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26' - 11 1/4" 26' - 11 1/4"	26' - 7 1/4"	
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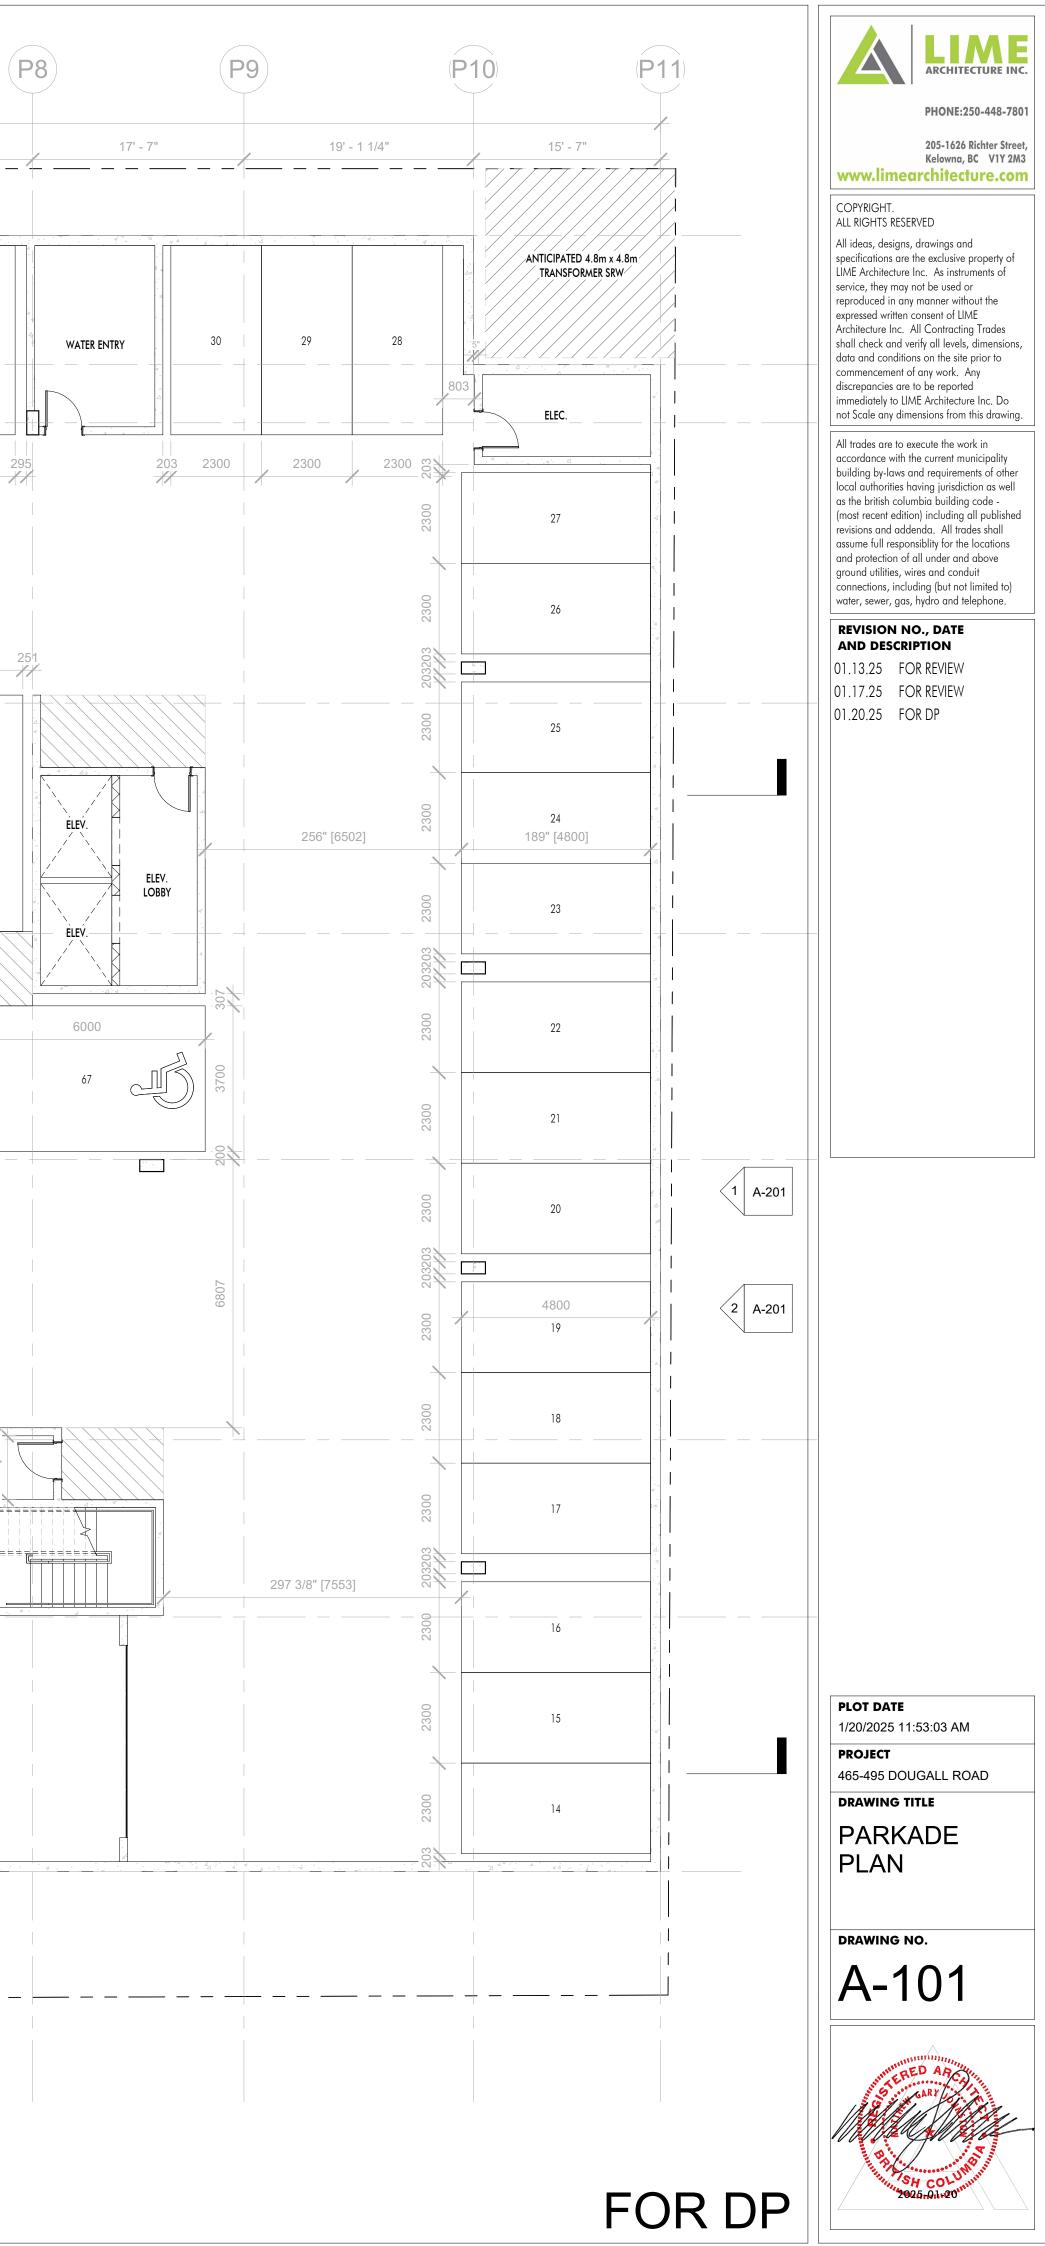
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55	56	57		58	59	60		61	62	63	64	65	66
'6	75	74		73	72	71		70	69	68	1800-174 TYP. 20 BICYCL	TYP.	
500	2500	2500	200206	2500	2500	2500	200206	2500	2500	2500	200 //	4	


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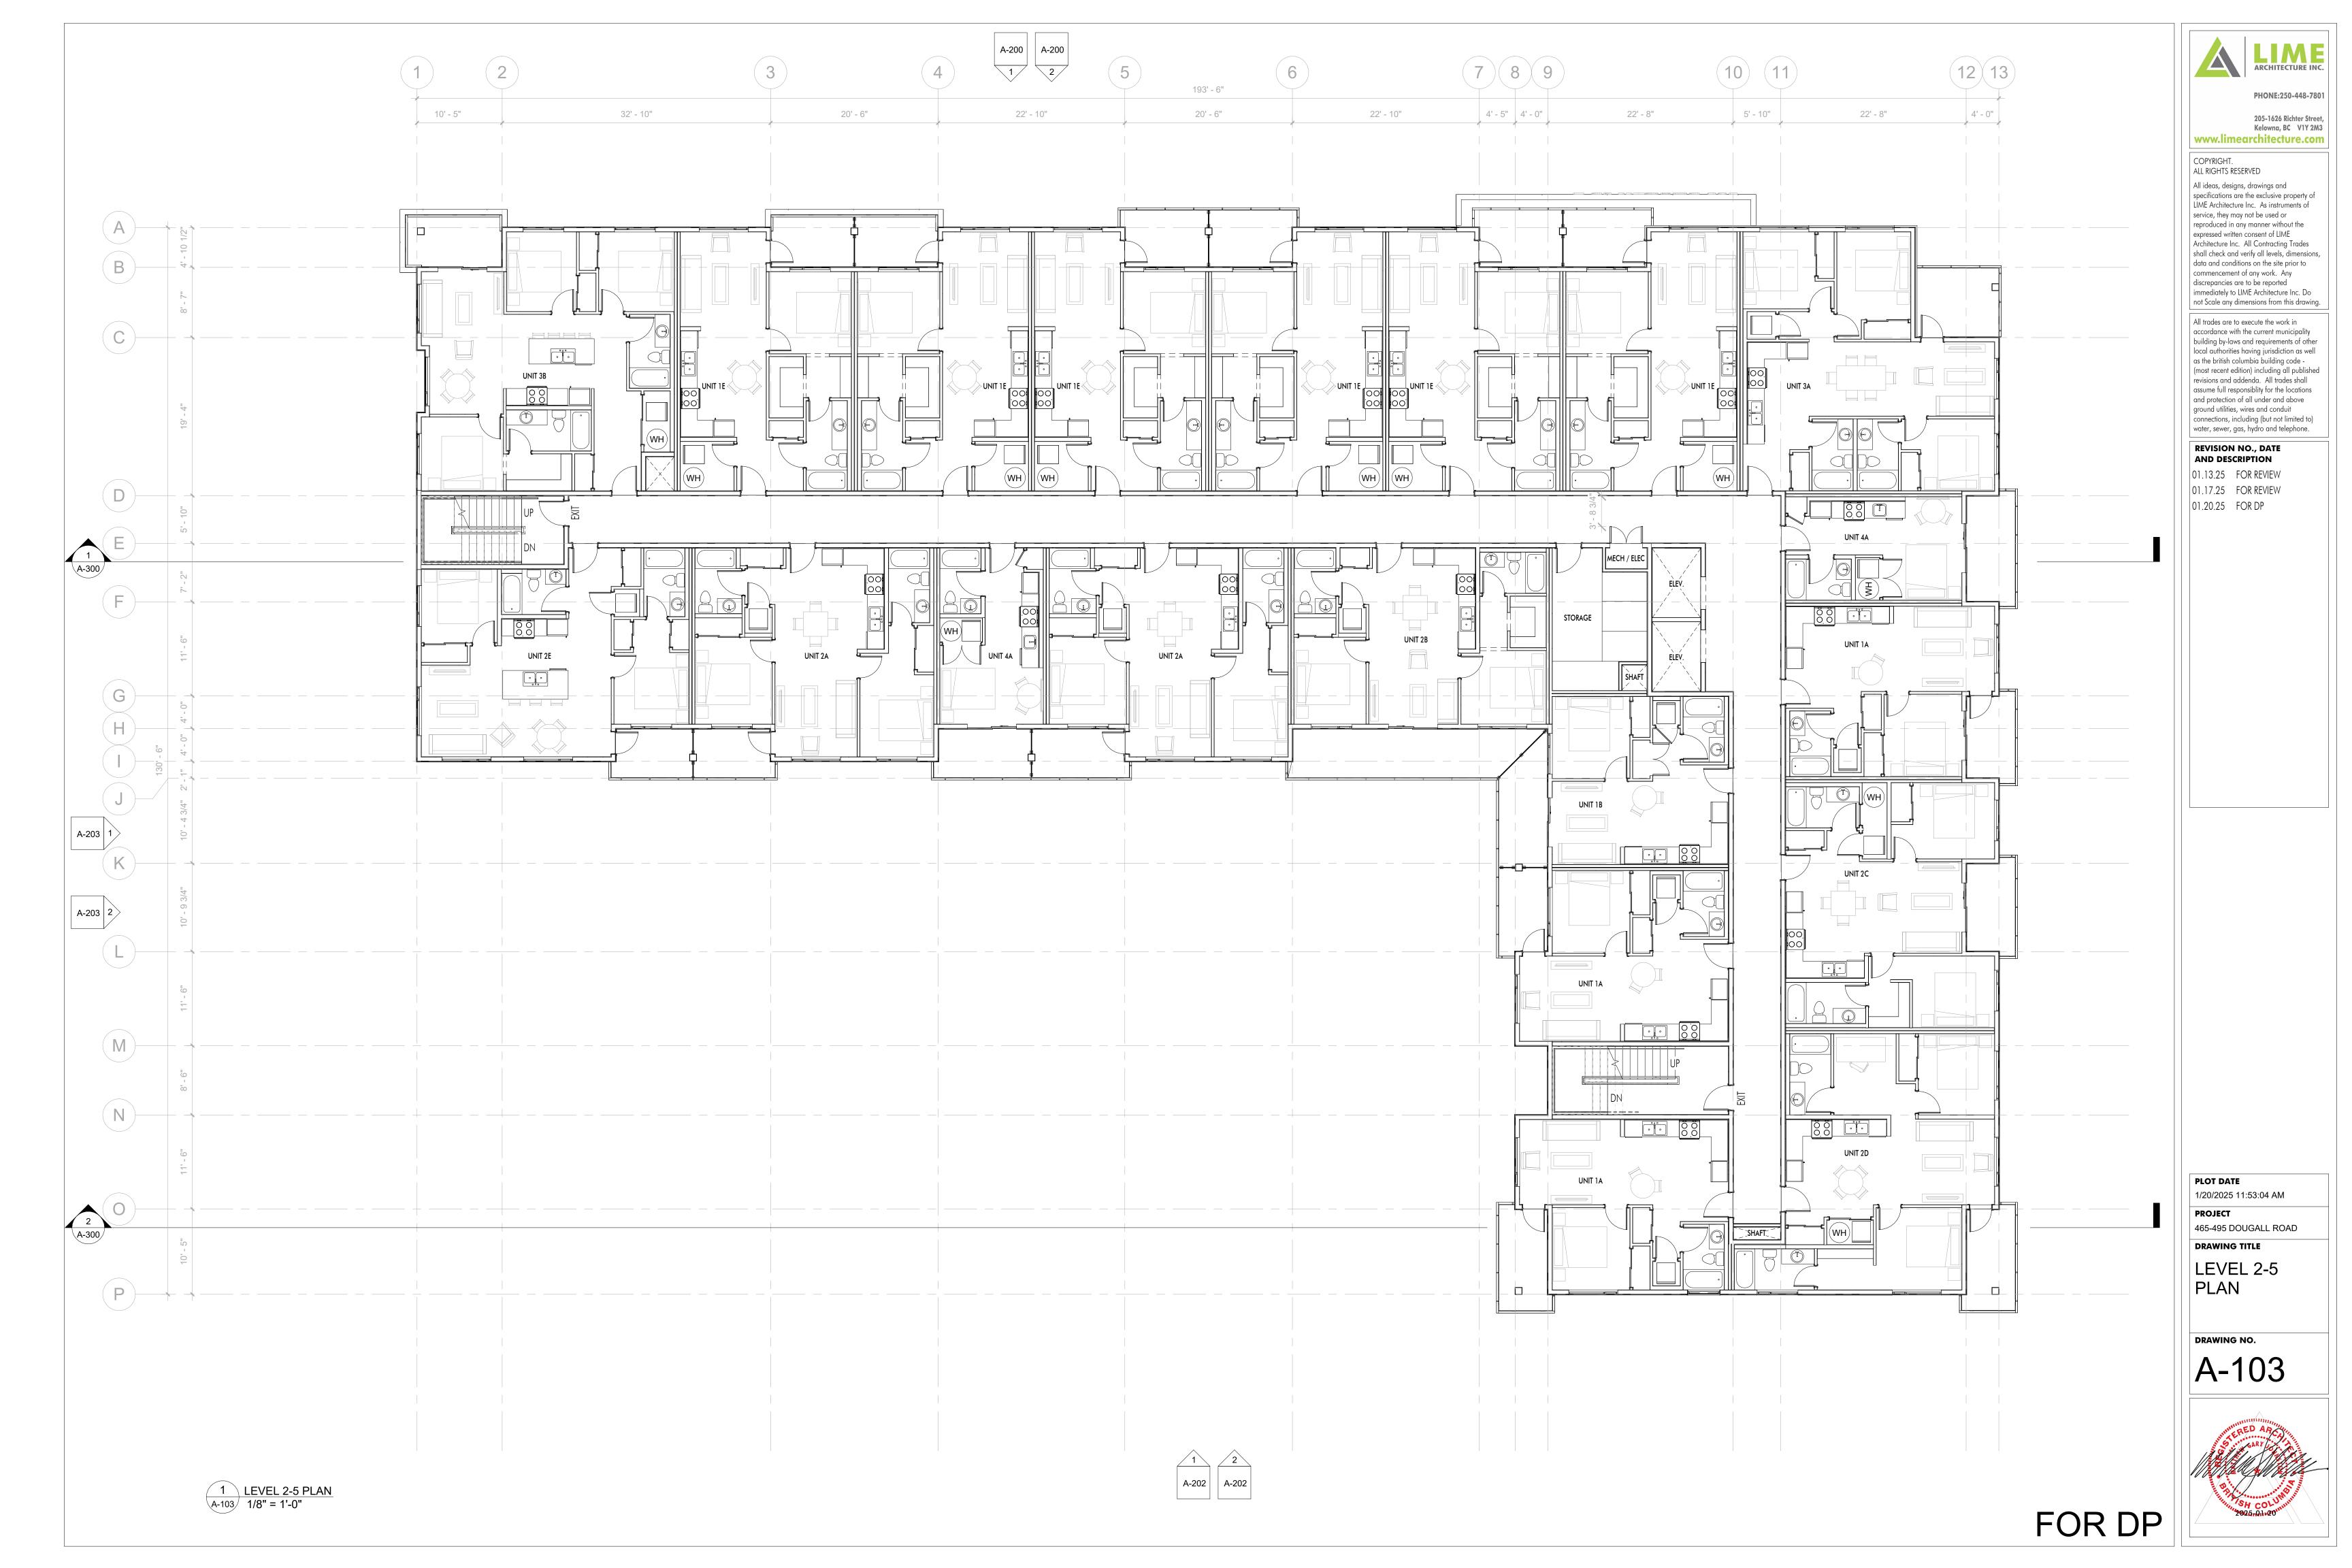
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90	<u>a</u>	91	92	93	94	95	96	97			189" [4800]	ELEC.	
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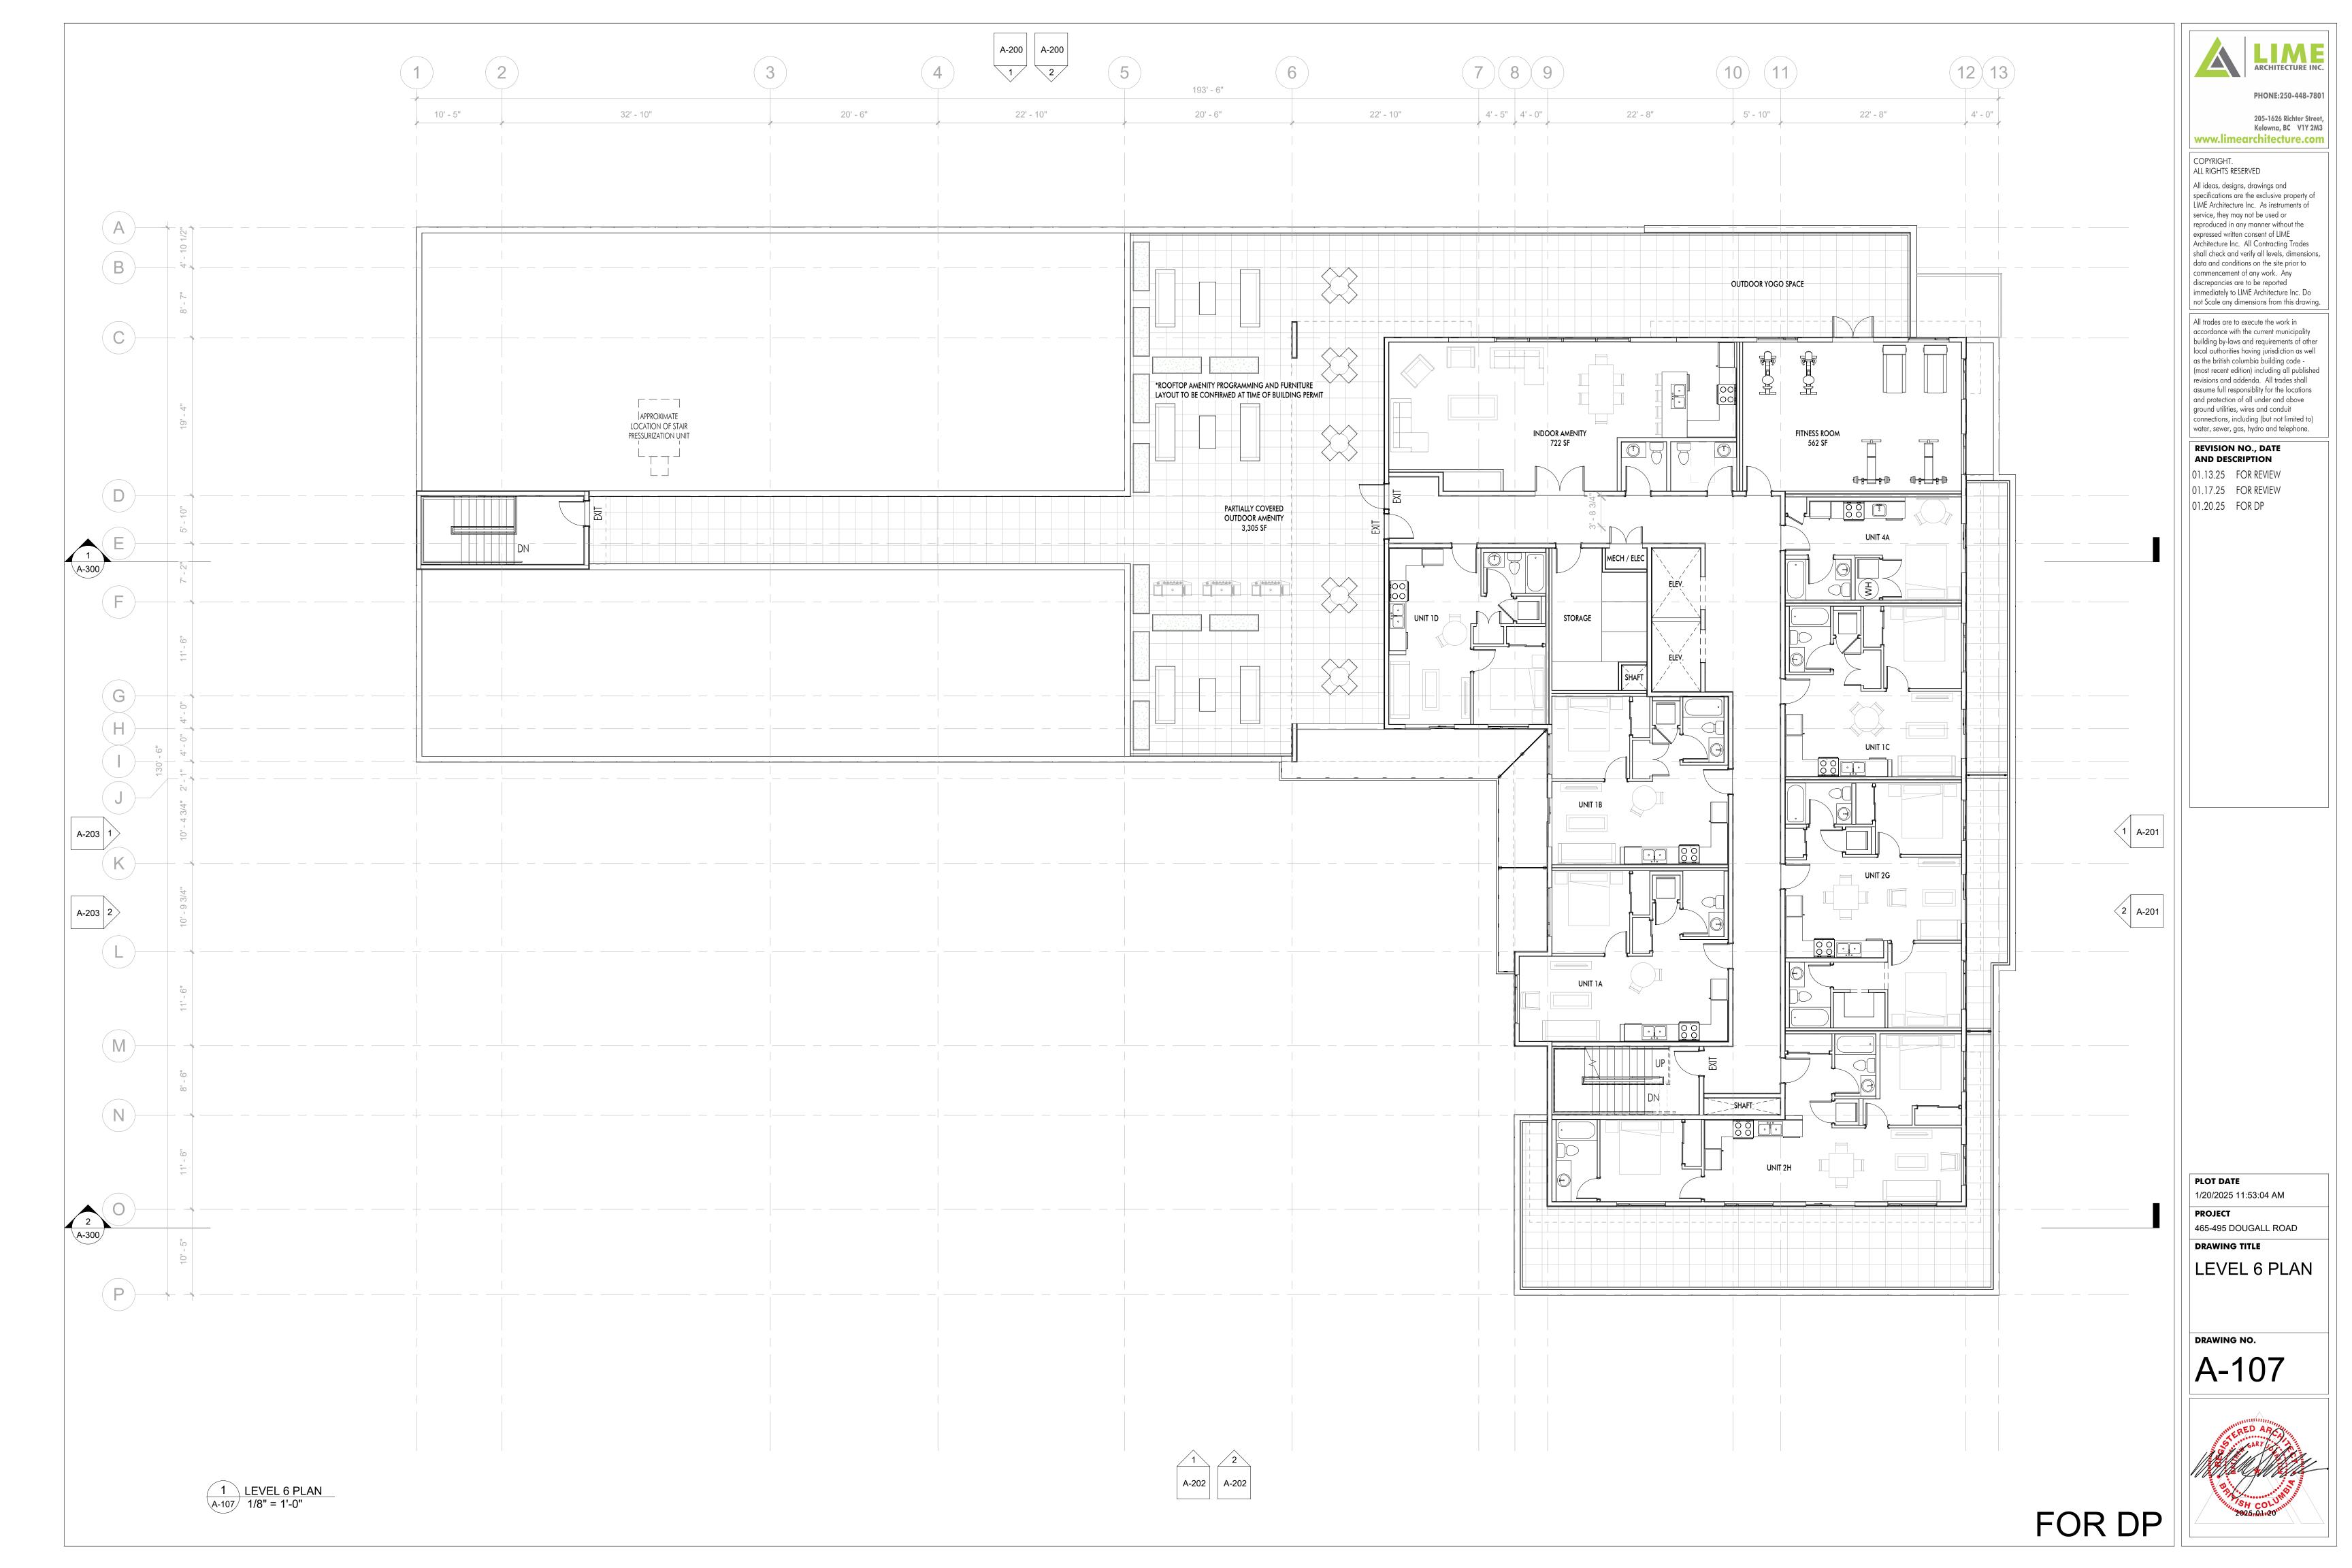
236 1/2" [6007]


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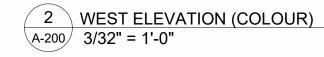




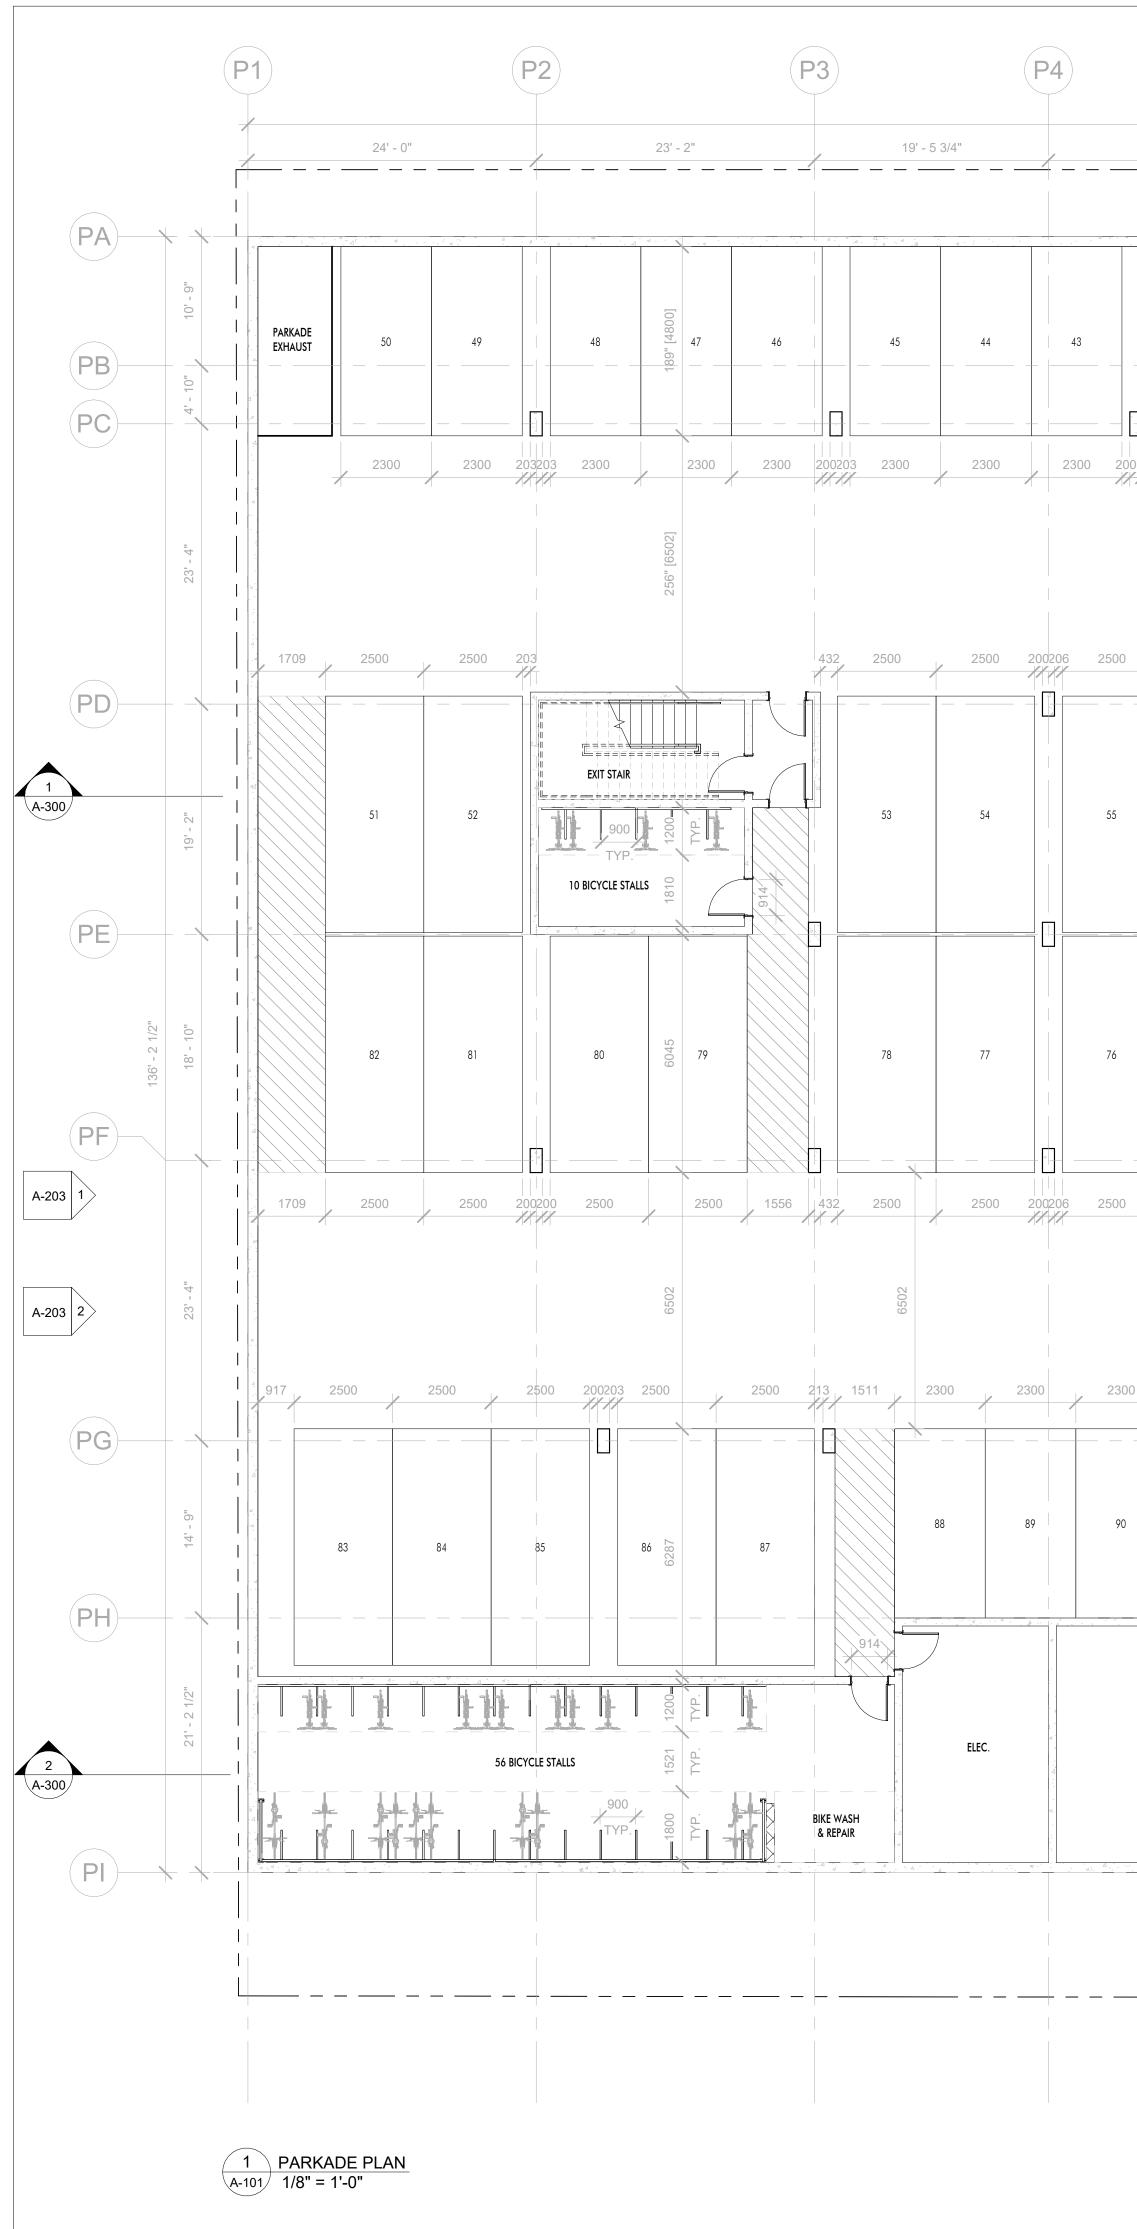




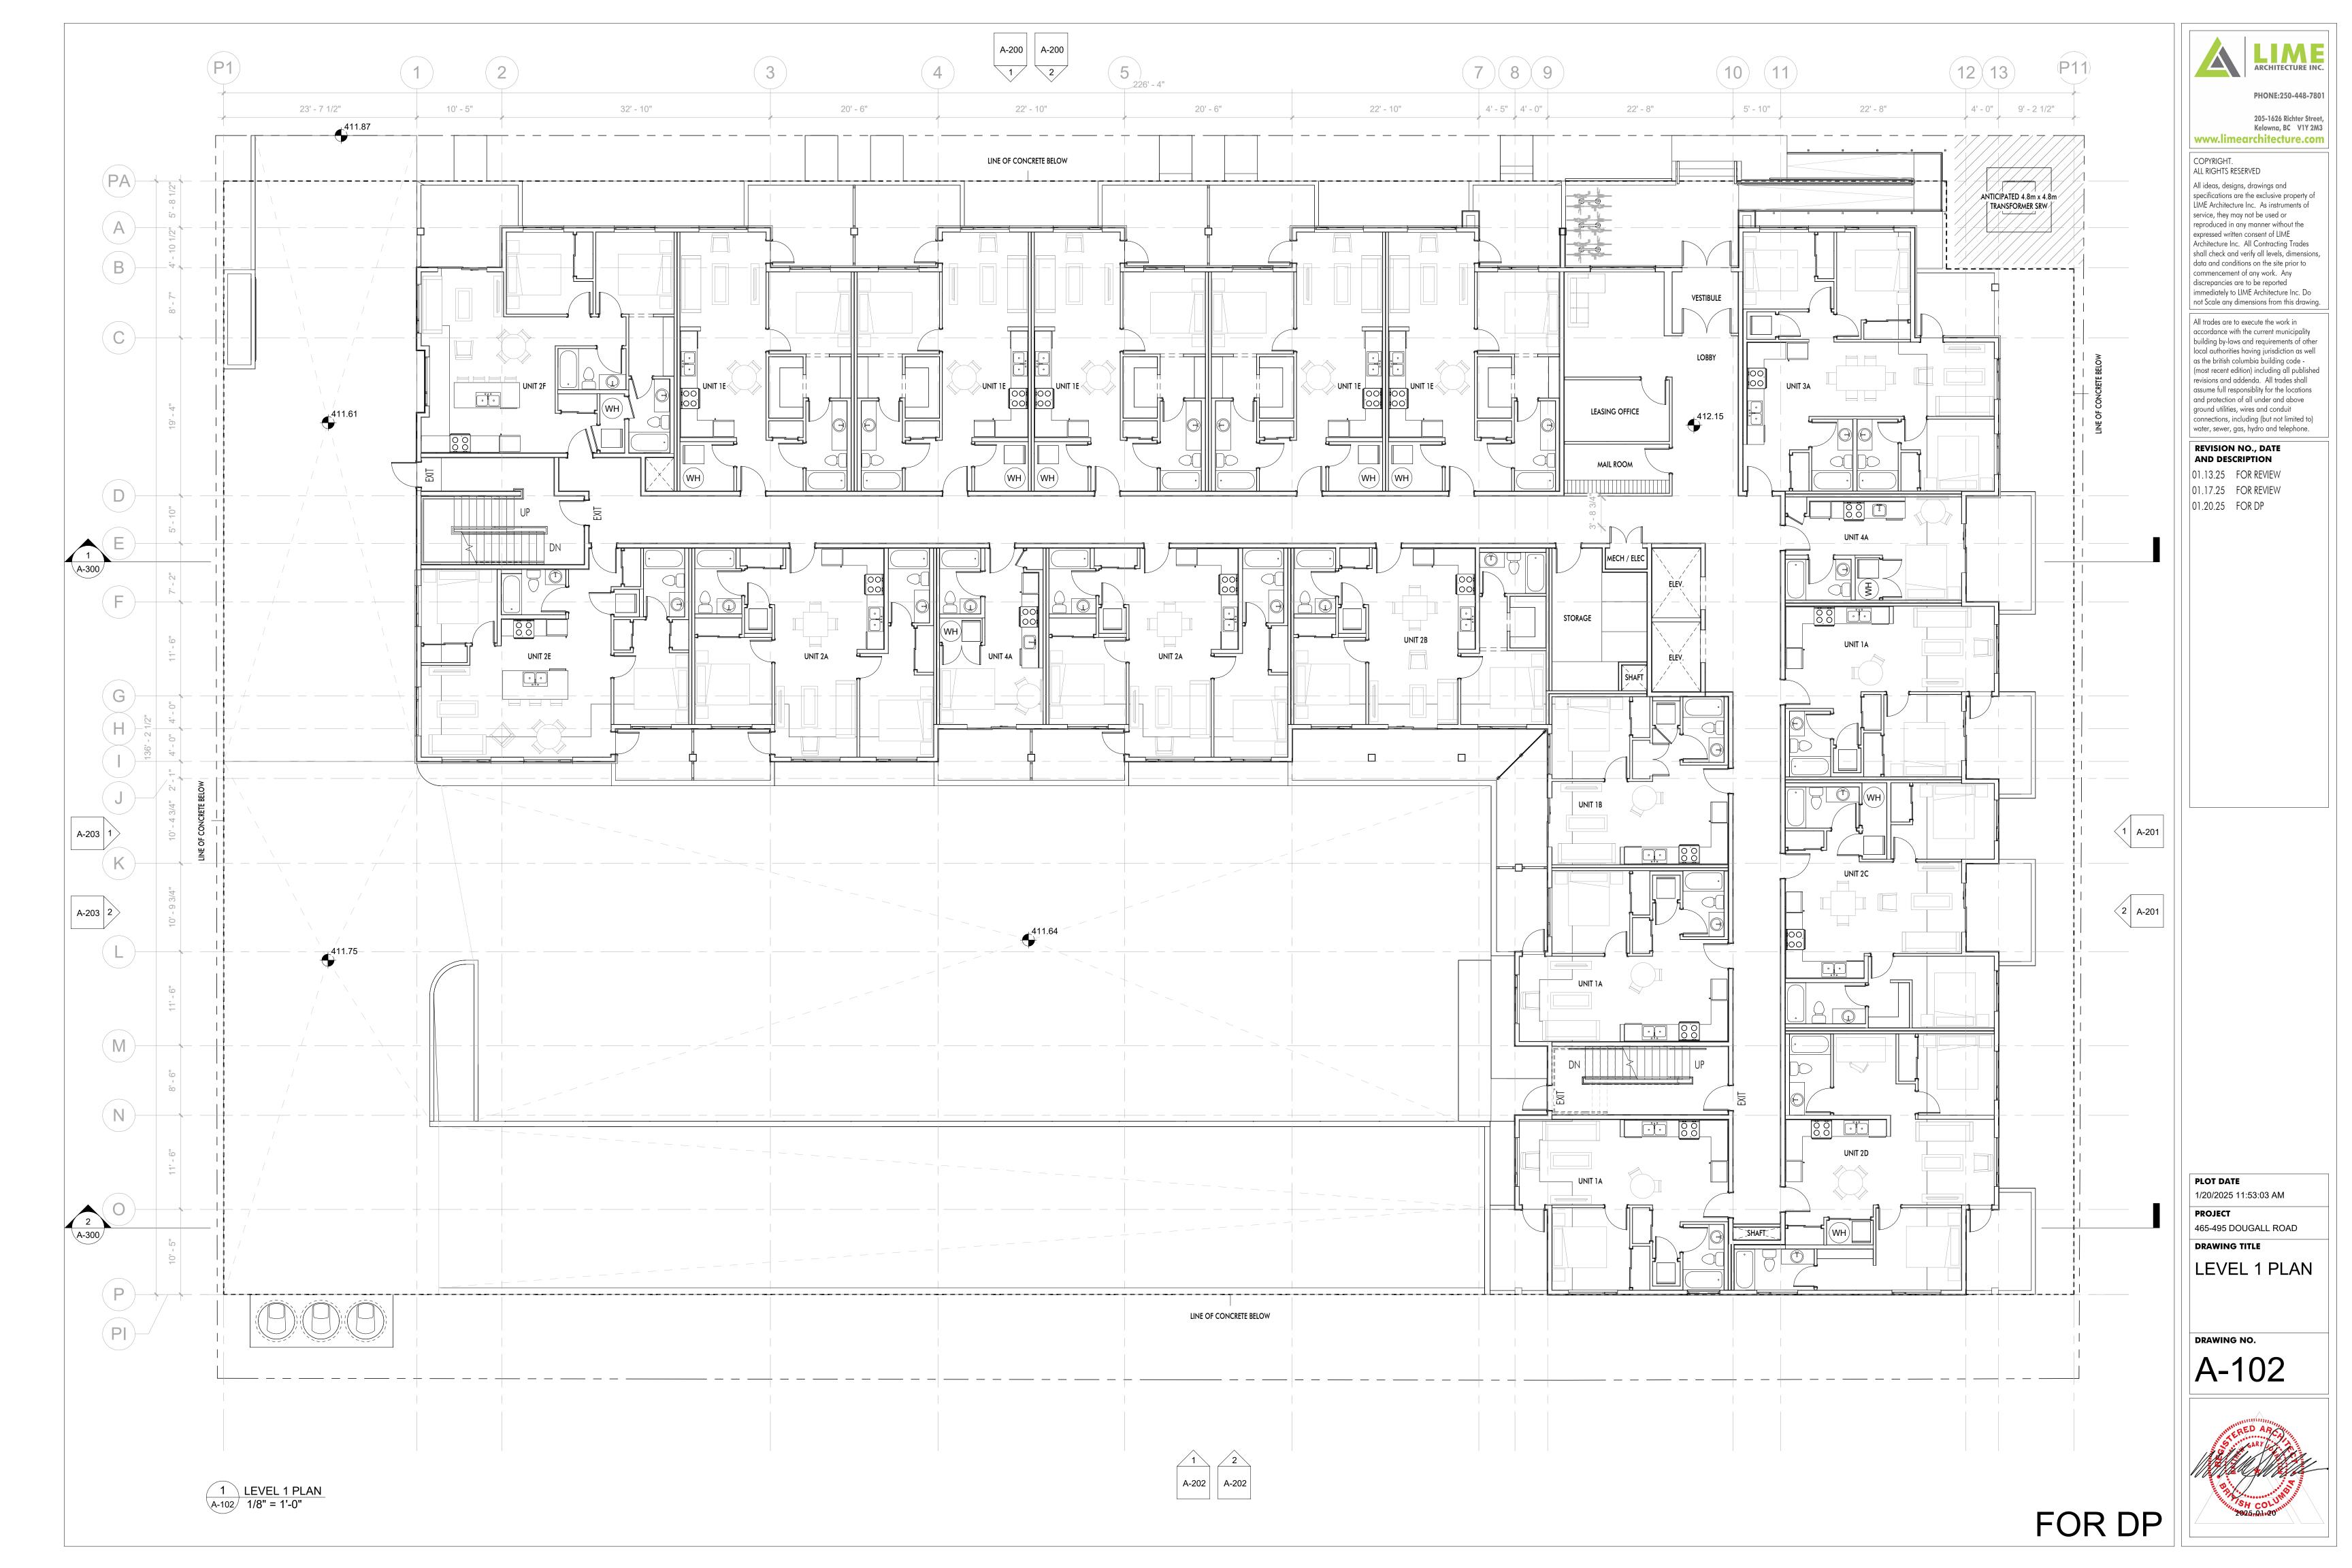

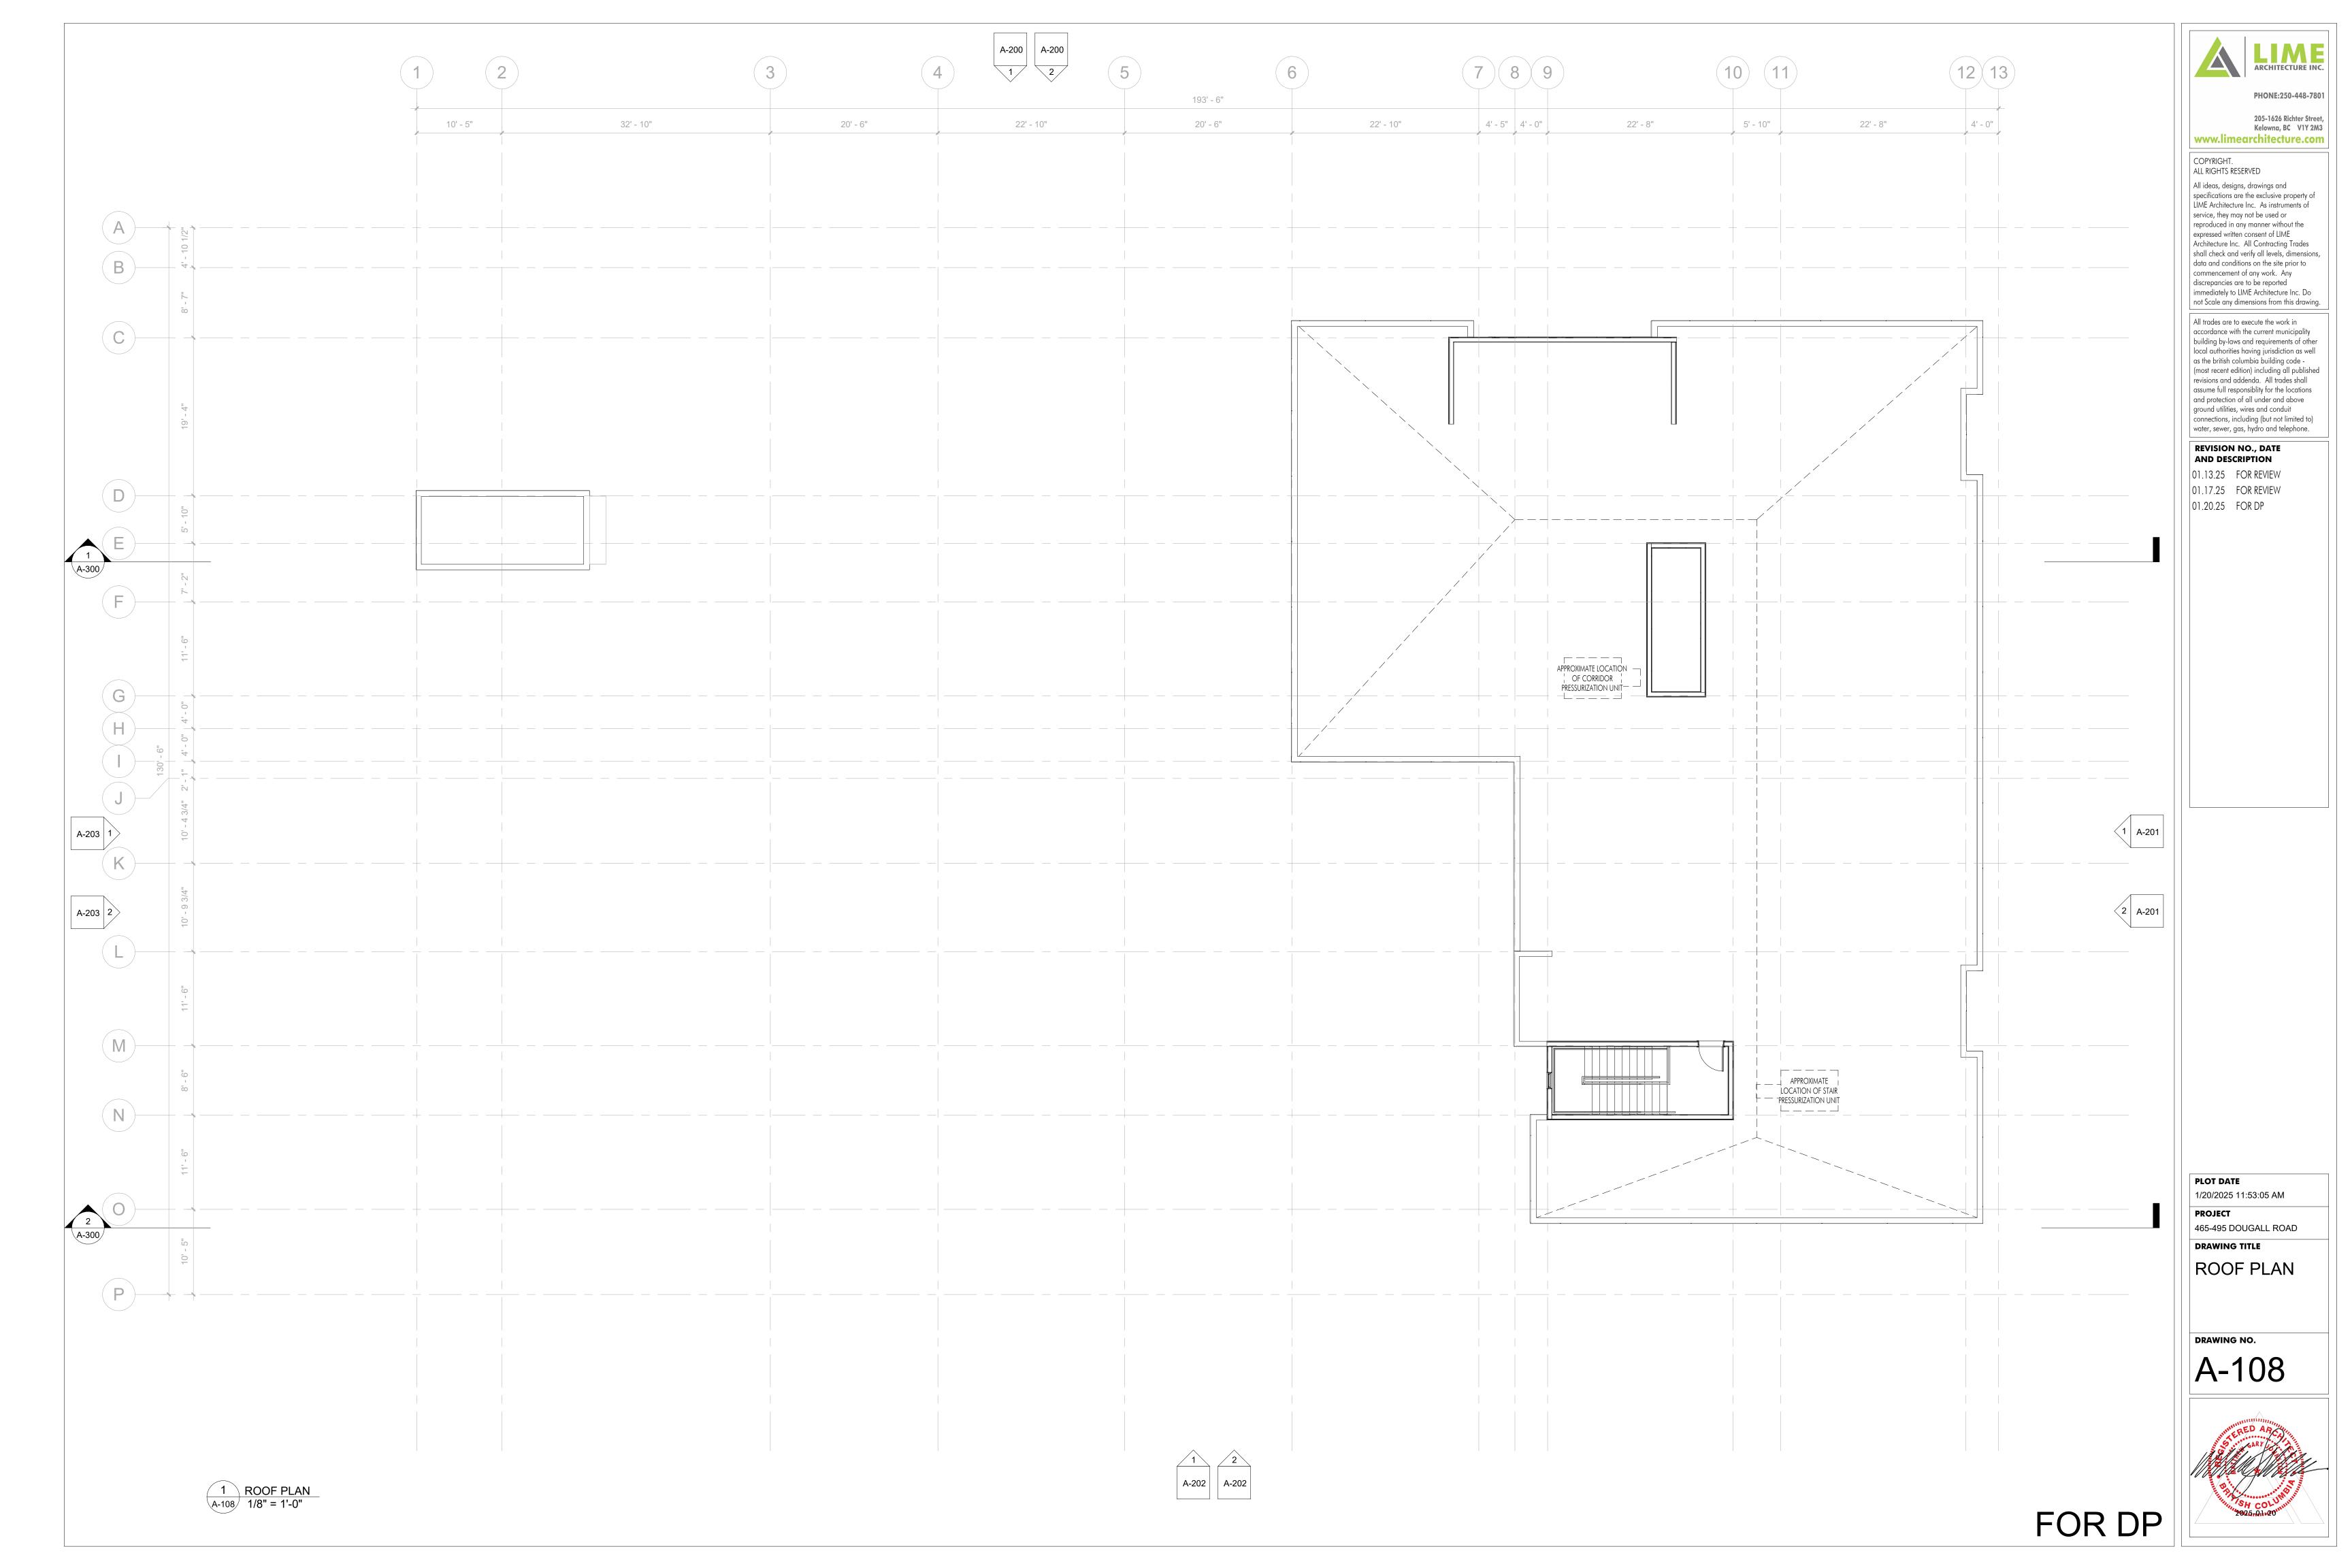



1 WEST ELEVATION A-200 3/32" = 1'-0"

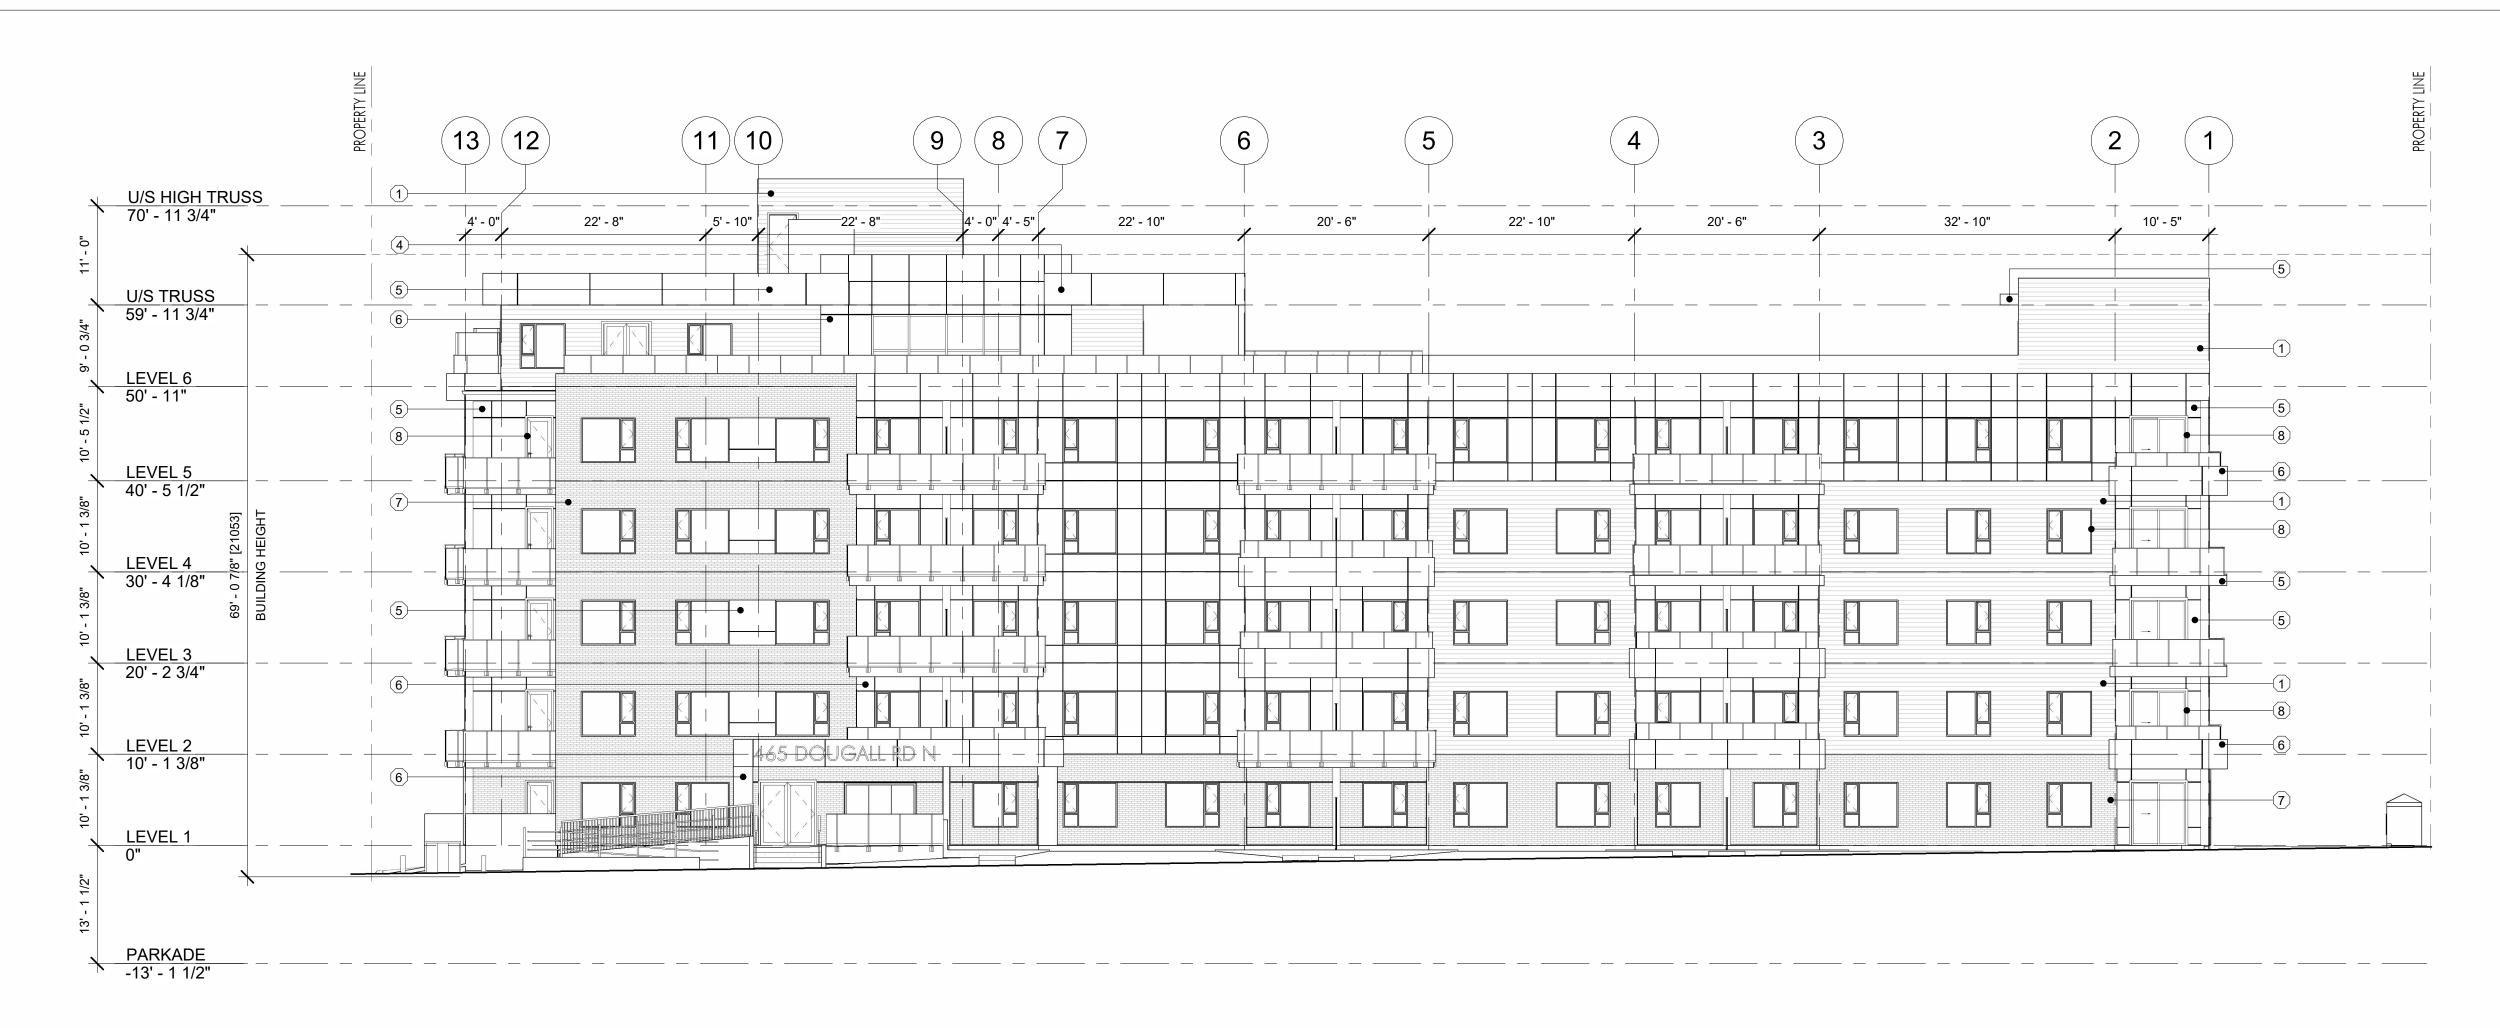

EXT	ERIOR FINISHE	S
\bigcirc	IMAGE	MATERIAL
1		FIBRE CEMENT CLADDING: HARDIE LAP, GRAY SLATE
2		FIBRE CEMENT CLADDING: HARDIE LAP, ARCTIC WHITE
3		FIBRE CEMENT CLADDING: HARDIE LAP WITH FISHER COATING, CEDARTONE
4		FIBRE CEMENT CLADDING: HARDIE PANEL, GRAY SLATE
5		FIBRE CEMENT CLADDING: HARDIE PANEL, ARCTIC WHITE
6		FIBRE CEMENT CLADDING: HARDIE PANEL TO MATCH FISHER COATING, CEDARTONE
7		BRICK VENEER: CULTURED STONE, CARBON
8		WINDOWS, DOORS, RAILINGS, FASCIA: BLACK



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465-495 DOUGALL ROAD DRAWING TITLE


WEST ELEVATIONS

DRAWING NO.








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DRAWING TITLE

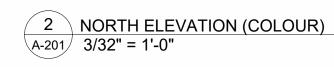NORTH

PLOT DATE

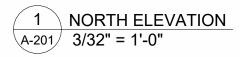PROJECT

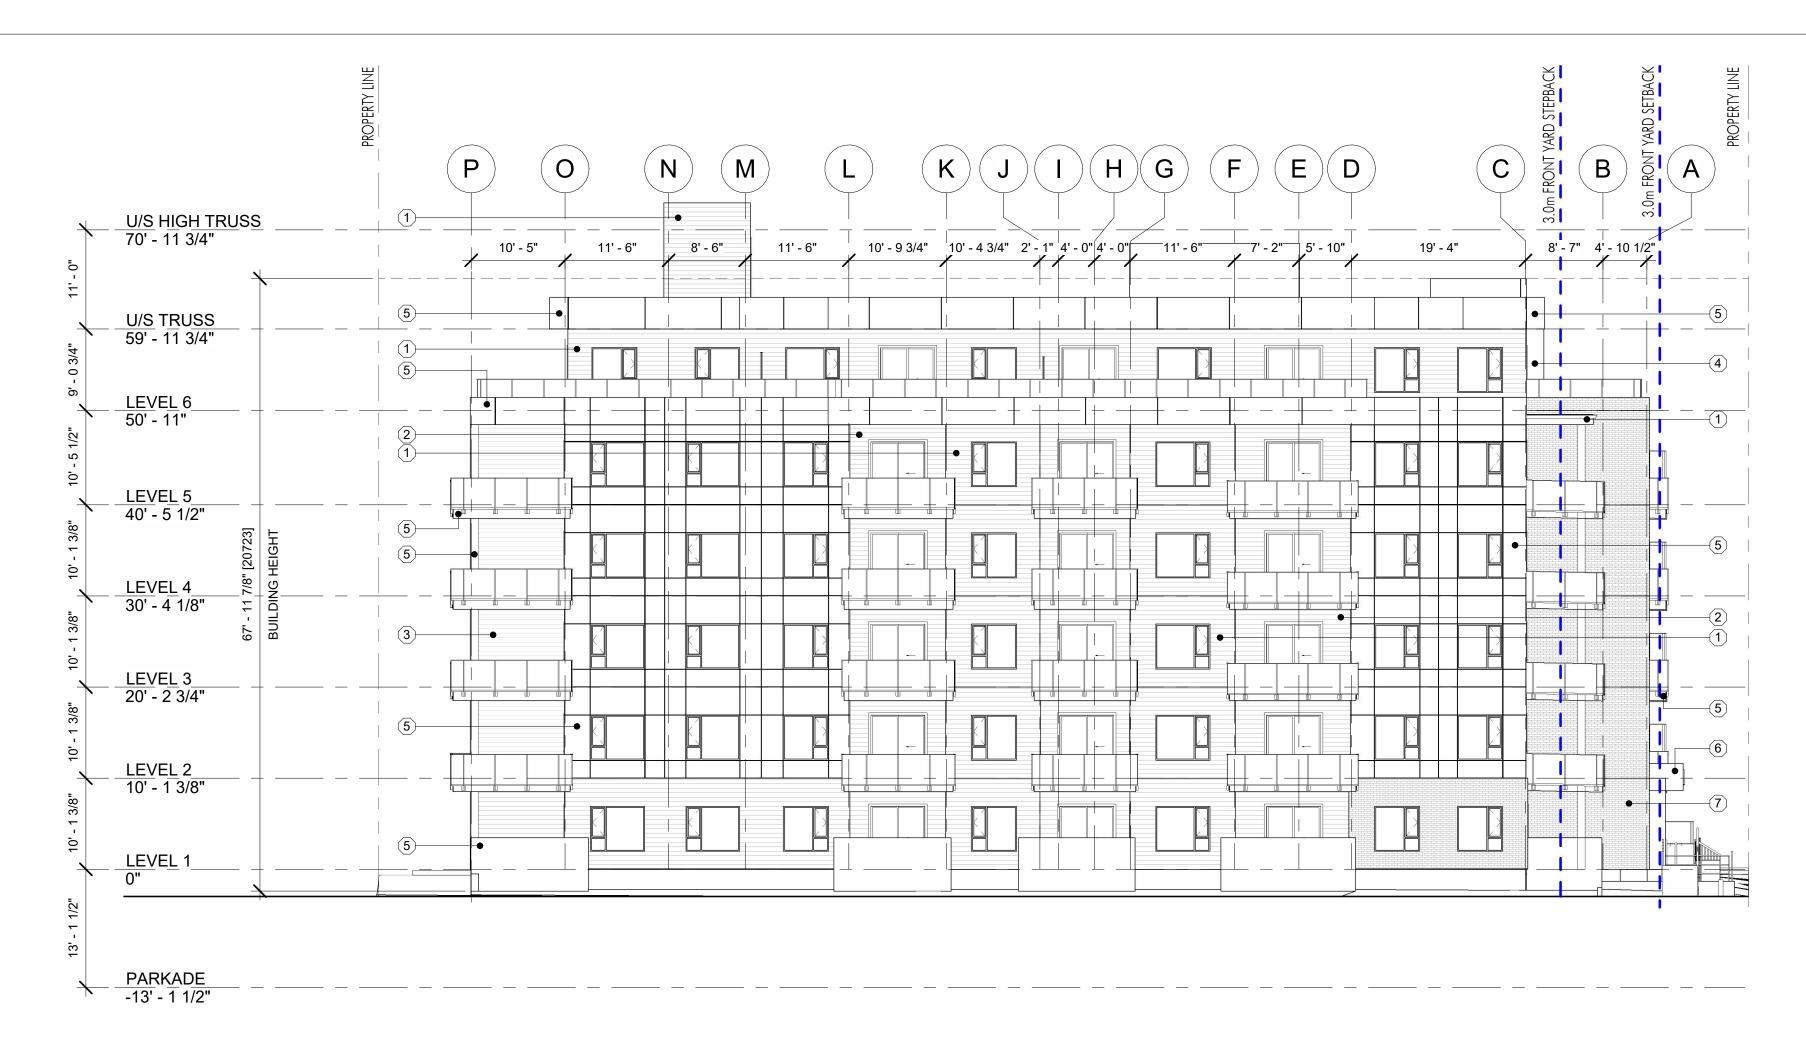1/20/2025 11:53:31 AM

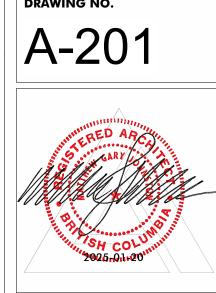465-495 DOUGALL ROAD

ELEVATIONS

EXT	ERIOR FINISHE	S
\bigcirc	IMAGE	MATERIAL
1	panet *	FIBRE CEMENT CLADDING: HARDIE LAP, GRAY SLATE
2		FIBRE CEMENT CLADDING: HARDIE LAP, ARCTIC WHITE
3		FIBRE CEMENT CLADDING: HARDIE LAP WITH FISHER COATING, CEDARTONE
4		FIBRE CEMENT CLADDING: HARDIE PANEL, GRAY SLATE
5		FIBRE CEMENT CLADDING: HARDIE PANEL, ARCTIC WHITE
6		FIBRE CEMENT CLADDING: HARDIE PANEL TO MATCH FISHER COATING, CEDARTONE
7		BRICK VENEER: CULTURED STONE, CARBON
8		WINDOWS, DOORS, RAILINGS, FASCIA: BLACK



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connections, including (but not limited to)

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commencement of any work. Any


All trades are to execute the work in

discrepancies are to be reported

shall check and verify all levels, dimensions,



1 EAST ELEVATION A-202 3/32" = 1'-0"

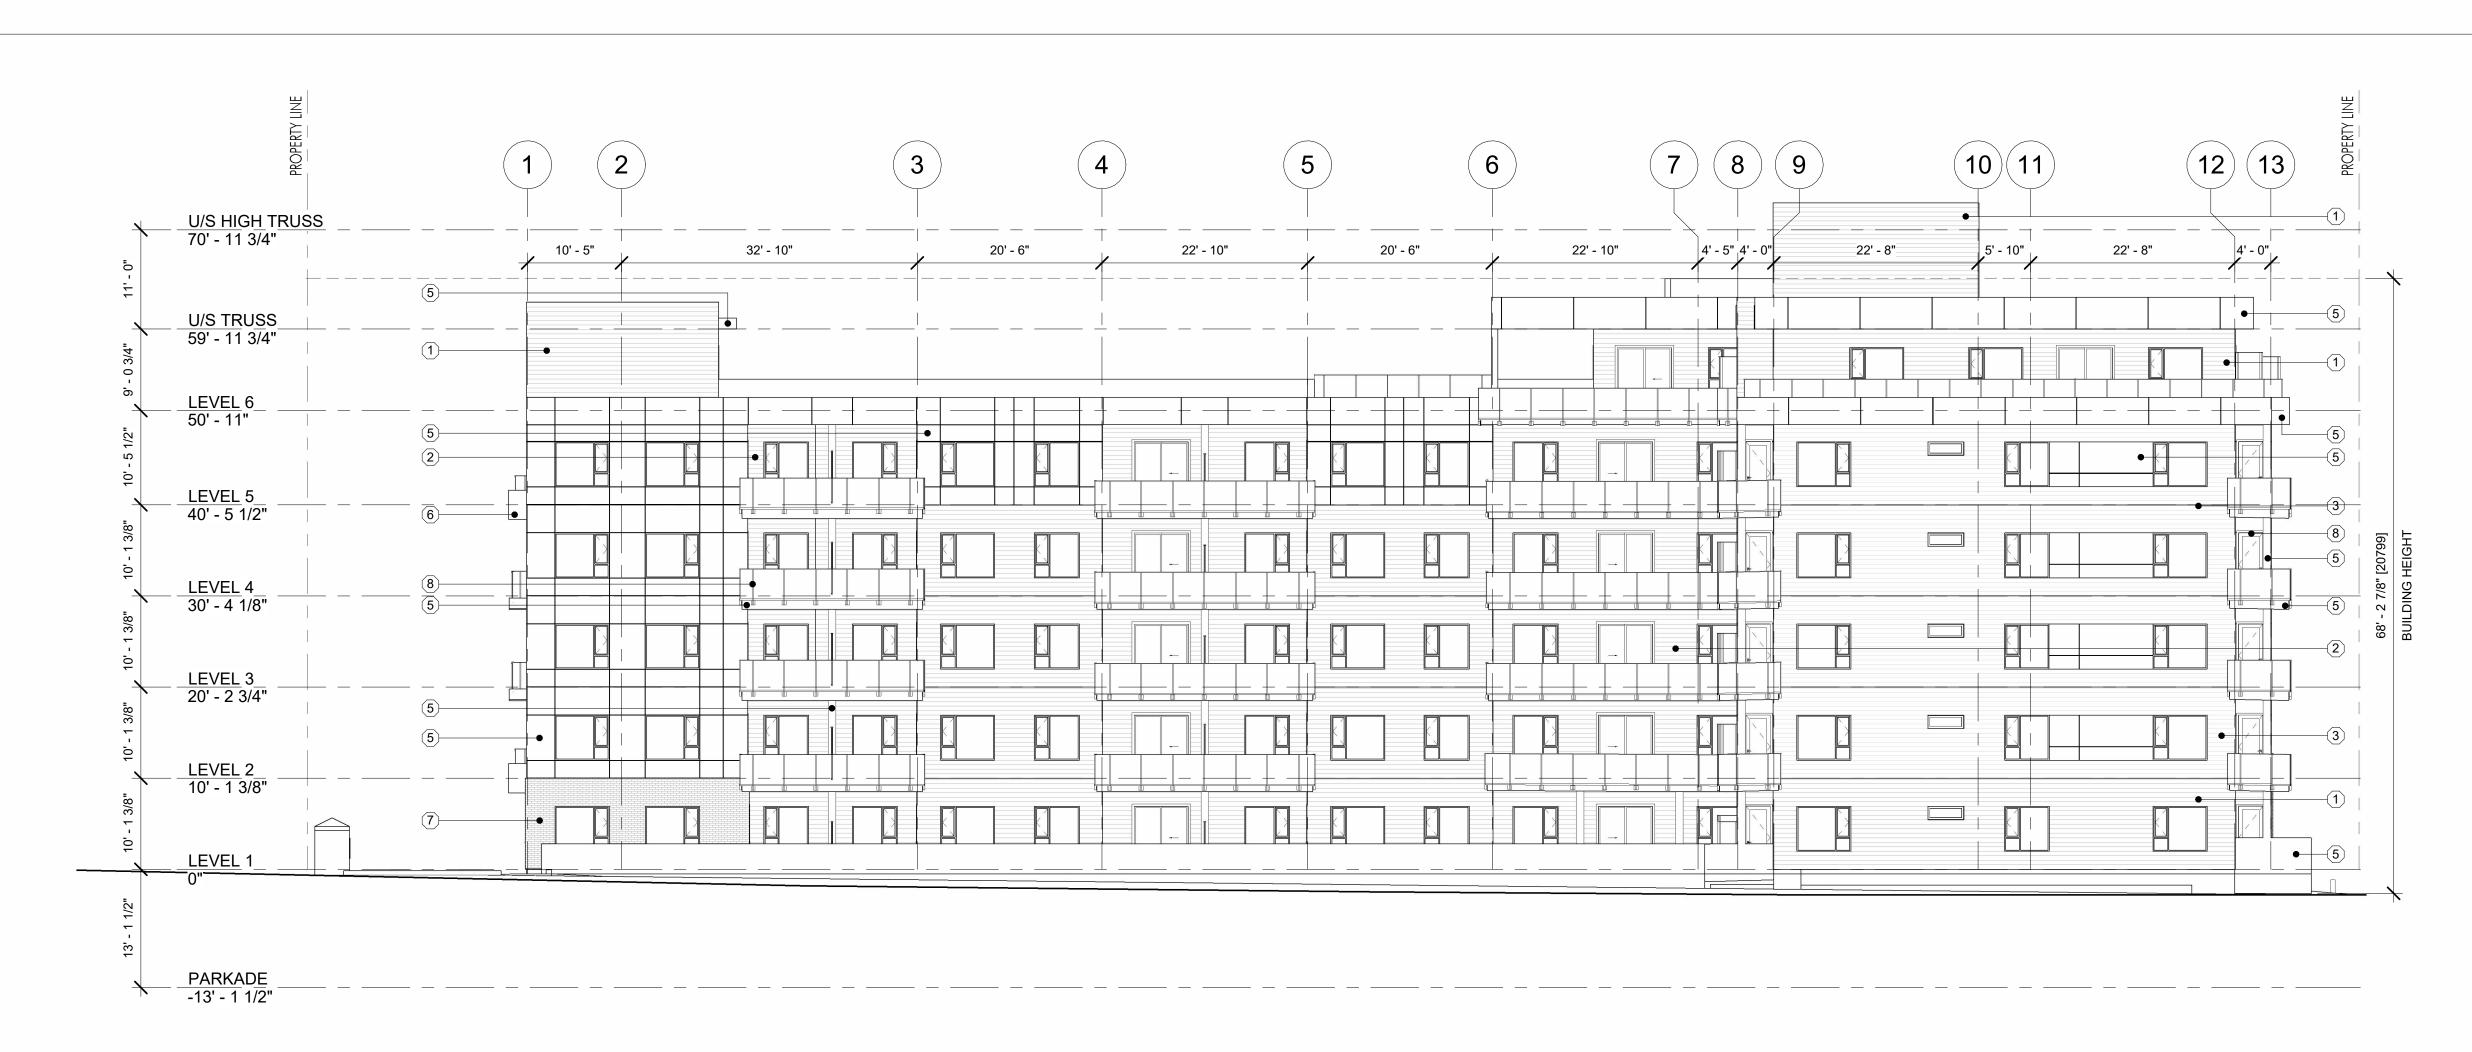

EXT	EXTERIOR FINISHES						
\bigcirc	IMAGE	MATERIAL					
1		FIBRE CEMENT CLADDING: HARDIE LAP, GRAY SLATE					
2	prover a	FIBRE CEMENT CLADDING: HARDIE LAP, ARCTIC WHITE					
3		FIBRE CEMENT CLADDING: HARDIE LAP WITH FISHER COATING, CEDARTONE					
4		FIBRE CEMENT CLADDING: HARDIE PANEL, GRAY SLATE					
5		FIBRE CEMENT CLADDING: HARDIE PANEL, ARCTIC WHITE					
6		FIBRE CEMENT CLADDING: HARDIE PANEL TO MATCH FISHER COATING, CEDARTONE					
7		BRICK VENEER: CULTURED STONE, CARBON					
8		WINDOWS, DOORS, RAILINGS, FASCIA: BLACK					



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01.13.25 FOR REVIEW 01.17.25 FOR REVIEW 01.20.25 FOR DP

FOR DP

DRAWING TITLE EAST ELEVATIONS

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465-495 DOUGALL ROAD

PLOT DATE

PROJECT


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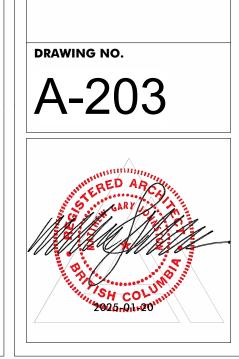






1 SOUTH ELEVATION A-203 3/32" = 1'-0"



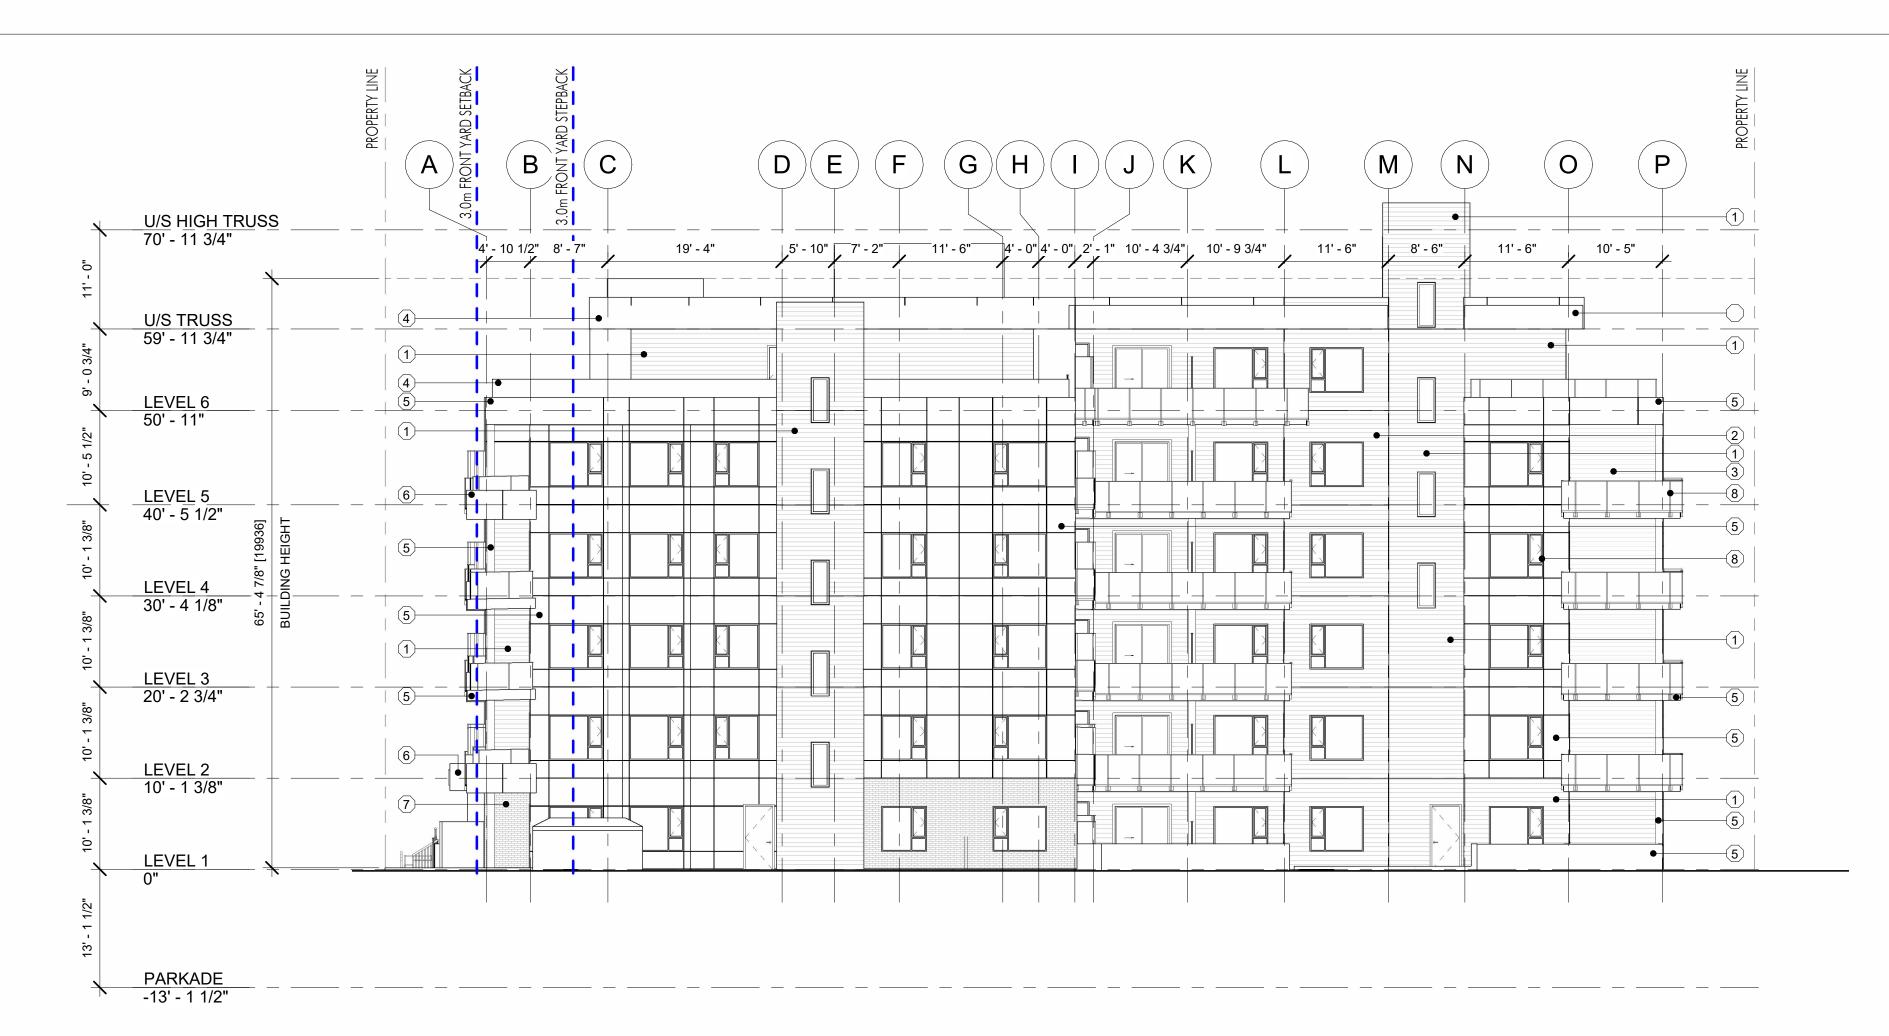

1/20/2025 11:54:00 AM PROJECT 465-495 DOUGALL ROAD DRAWING TITLE SOUTH

ELEVATIONS

PLOT DATE

EXT	ERIOR FINISHE	S
\bigcirc	IMAGE	MATERIAL
1	parent.	FIBRE CEMENT CLADDING: HARDIE LAP, GRAY SLATE
2		FIBRE CEMENT CLADDING: HARDIE LAP, ARCTIC WHITE
3		FIBRE CEMENT CLADDING: HARDIE LAP WITH FISHER COATING, CEDARTONE
4		FIBRE CEMENT CLADDING: HARDIE PANEL, GRAY SLATE
5		FIBRE CEMENT CLADDING: HARDIE PANEL, ARCTIC WHITE
6		FIBRE CEMENT CLADDING: HARDIE PANEL TO MATCH FISHER COATING, CEDARTONE
7		BRICK VENEER: CULTURED STONE, CARBON
8		WINDOWS, DOORS, RAILINGS, FASCIA: BLACK



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REVISION NO., DATE


water, sewer, gas, hydro and telephone.

 AND DESCRIPTION

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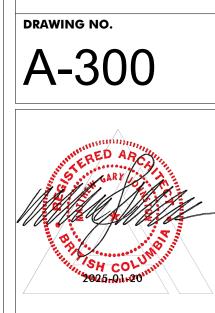
 01.17.25
 FOR REVIEW

 01.20.25
 FOR DP



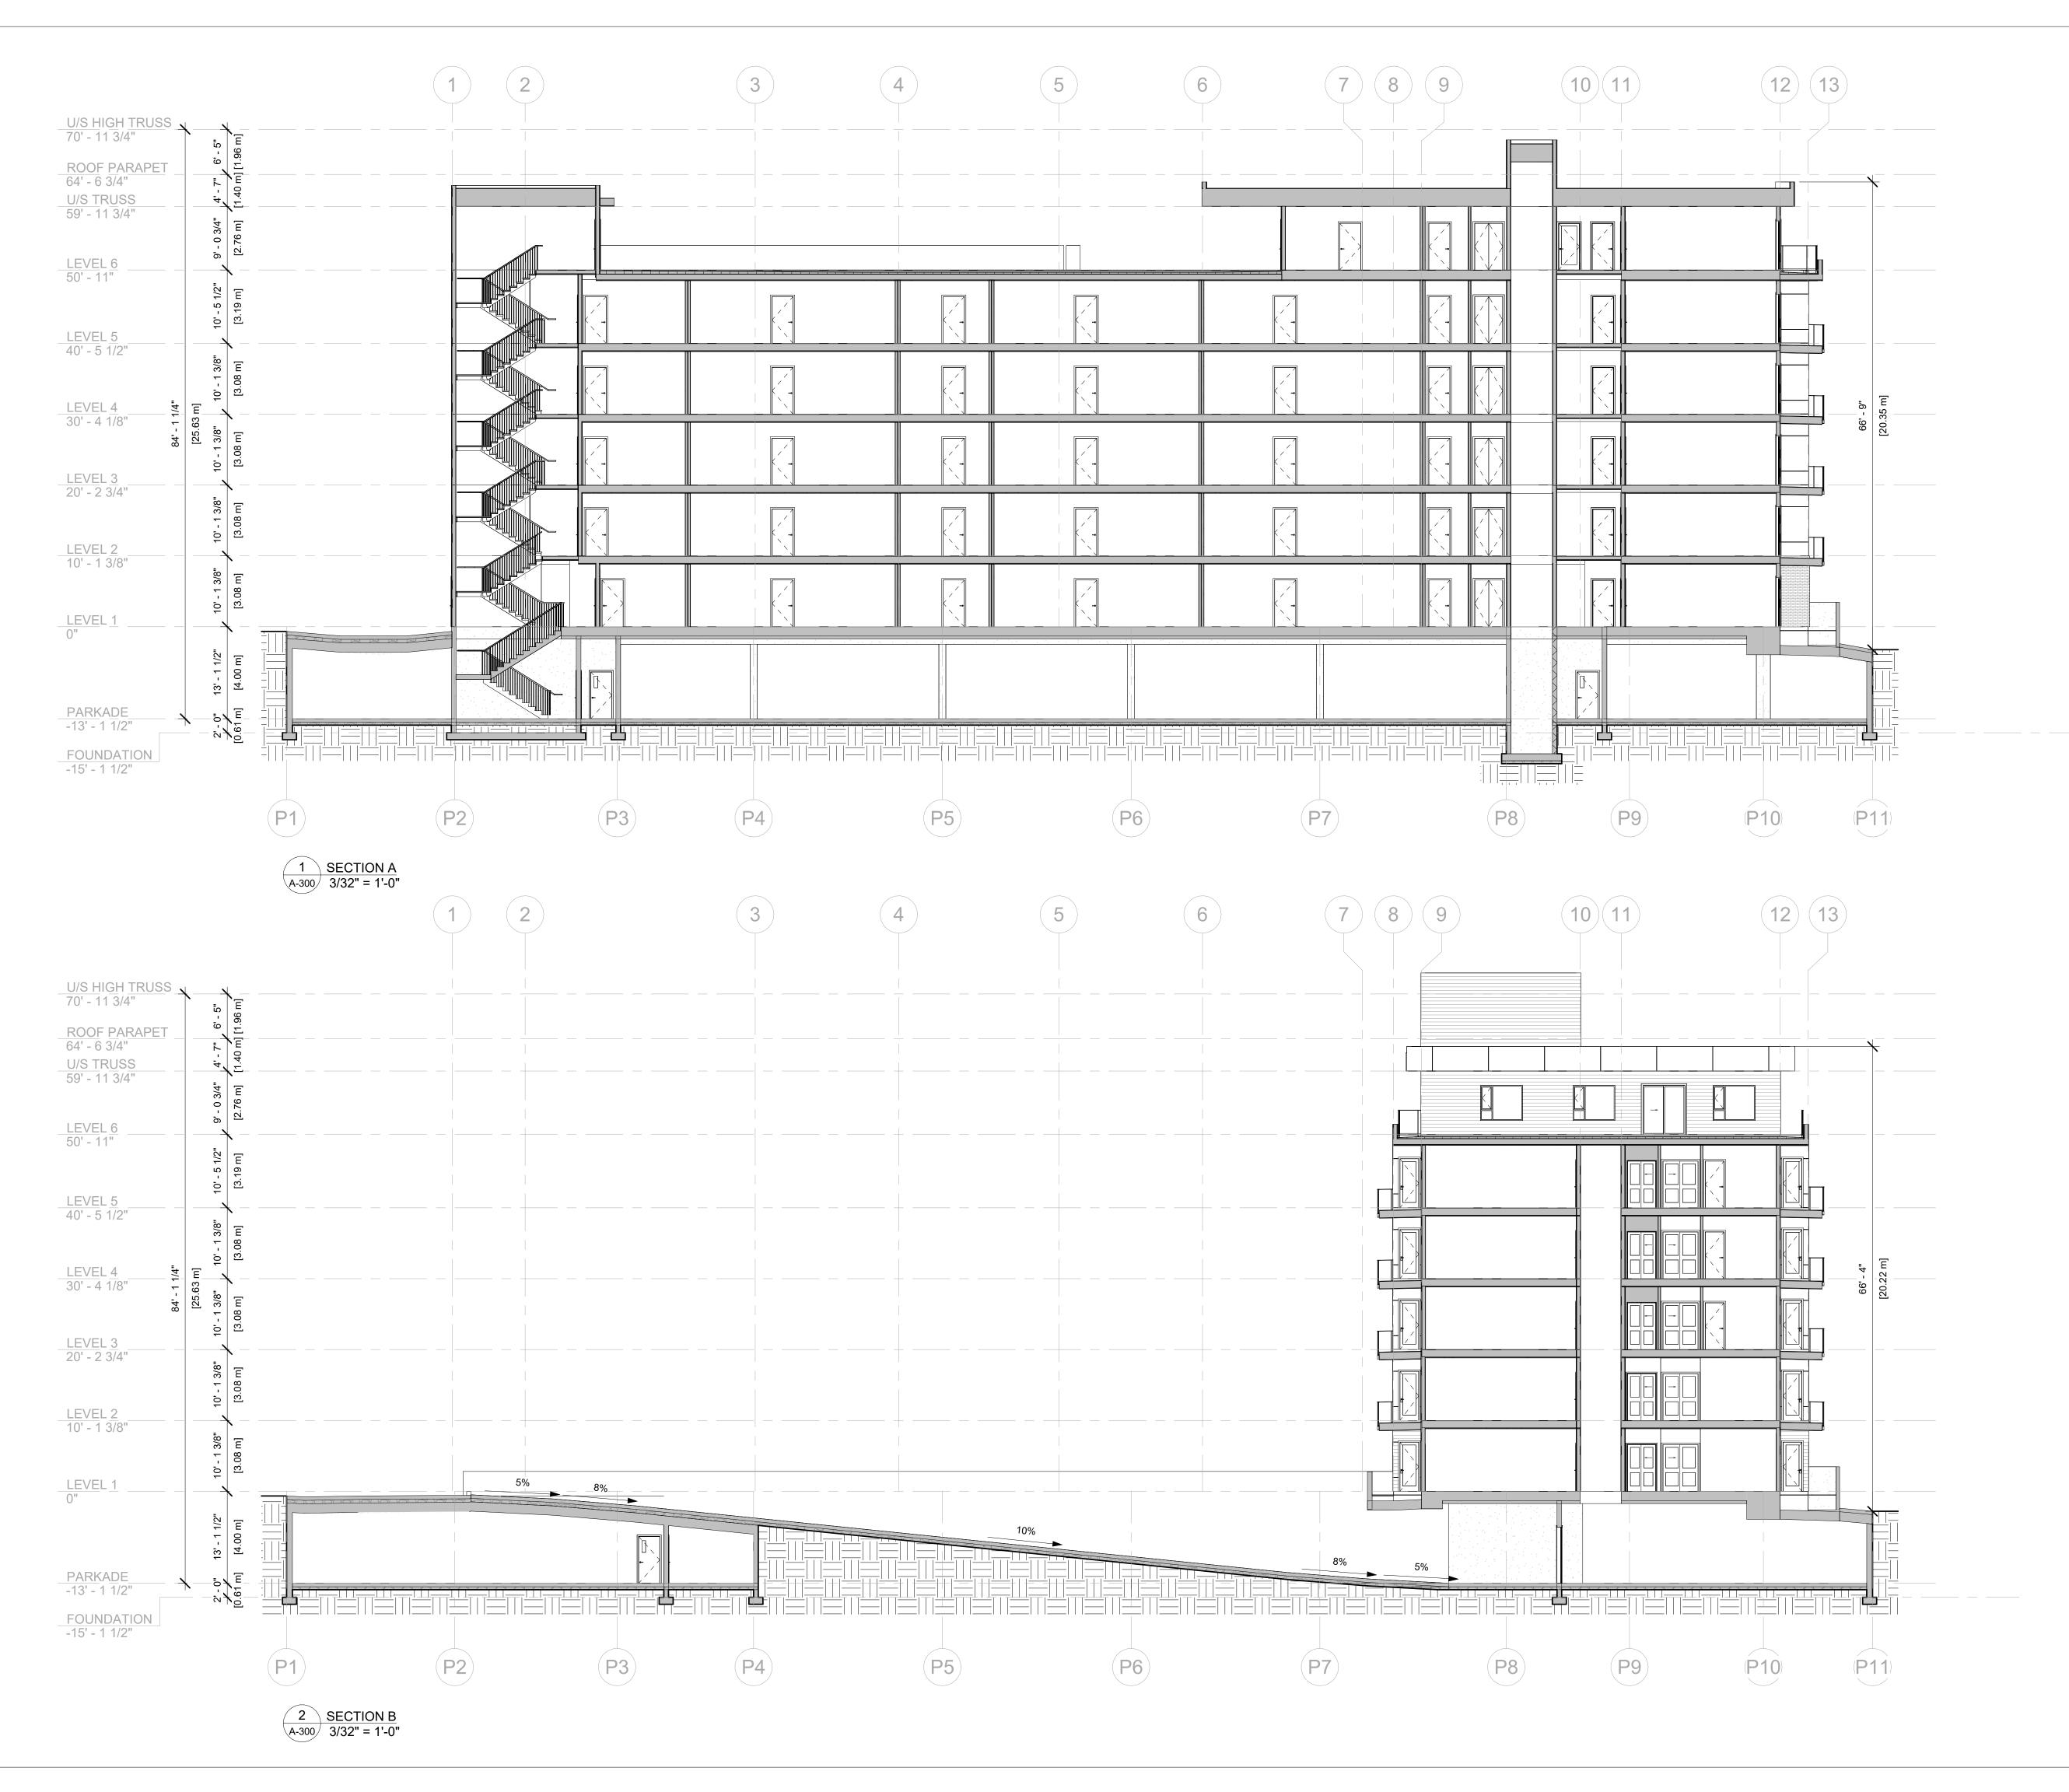





SECTIONS

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PLOT DATE

01.13.25 FOR REVIEW

REVISION NO., DATE

AND DESCRIPTION 01.17.25 FOR REVIEW 01.20.25 FOR DP

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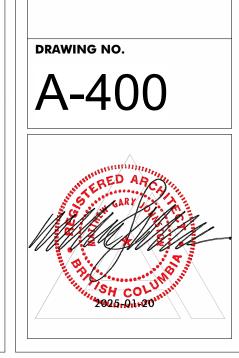
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AND DESCRIPTION 01.13.25 FOR REVIEW 01.17.25 FOR REVIEW

01.20.25 FOR DP

local authorities having jurisdiction as well as the british columbia building code -(most recent edition) including all published revisions and addenda. All trades shall assume full responsibility for the locations and protection of all under and above ground utilities, wires and conduit connections, including (but not limited to) water, sewer, gas, hydro and telephone.

REVISION NO., DATE

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PHONE:250-448-7801


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465-495 DOUGALL ROAD DRAWING TITLE RENDERINGS

PLOT DATE 1/20/2025 11:58:30 AM PROJECT

ground utilities, wires and conduit connections, including (but not limited to) water, sewer, gas, hydro and telephone.

REVISION NO., DATE AND DESCRIPTION 01.13.25 FOR REVIEW

01.17.25 FOR REVIEW 01.20.25 FOR DP
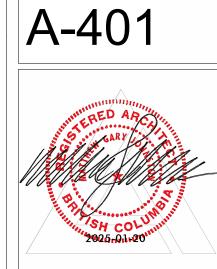
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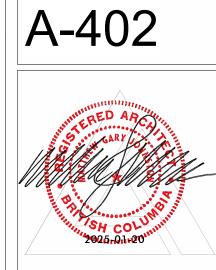


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DRAWING TITLE RENDERINGS

PLOT DATE 1/20/2025 12:00:46 PM PROJECT 465-495 DOUGALL ROAD

ground utilities, wires and conduit connections, including (but not limited to) water, sewer, gas, hydro and telephone. **REVISION NO., DATE**

AND DESCRIPTION 01.13.25 FOR REVIEW 01.17.25 FOR REVIEW 01.20.25 FOR DP

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accordance with the current municipality building by-laws and requirements of other local authorities having jurisdiction as well as the british columbia building code -(most recent edition) including all published revisions and addenda. All trades shall assume full responsibility for the locations and protection of all under and above around utilities wires and conduit ground utilities, wires and conduit connections, including (but not limited to) water, sewer, gas, hydro and telephone.

01.13.25 FOR REVIEW 01.17.25 FOR REVIEW 01.20.25 FOR DP

PLOT DATE

PROJECT

DRAWING TITLE

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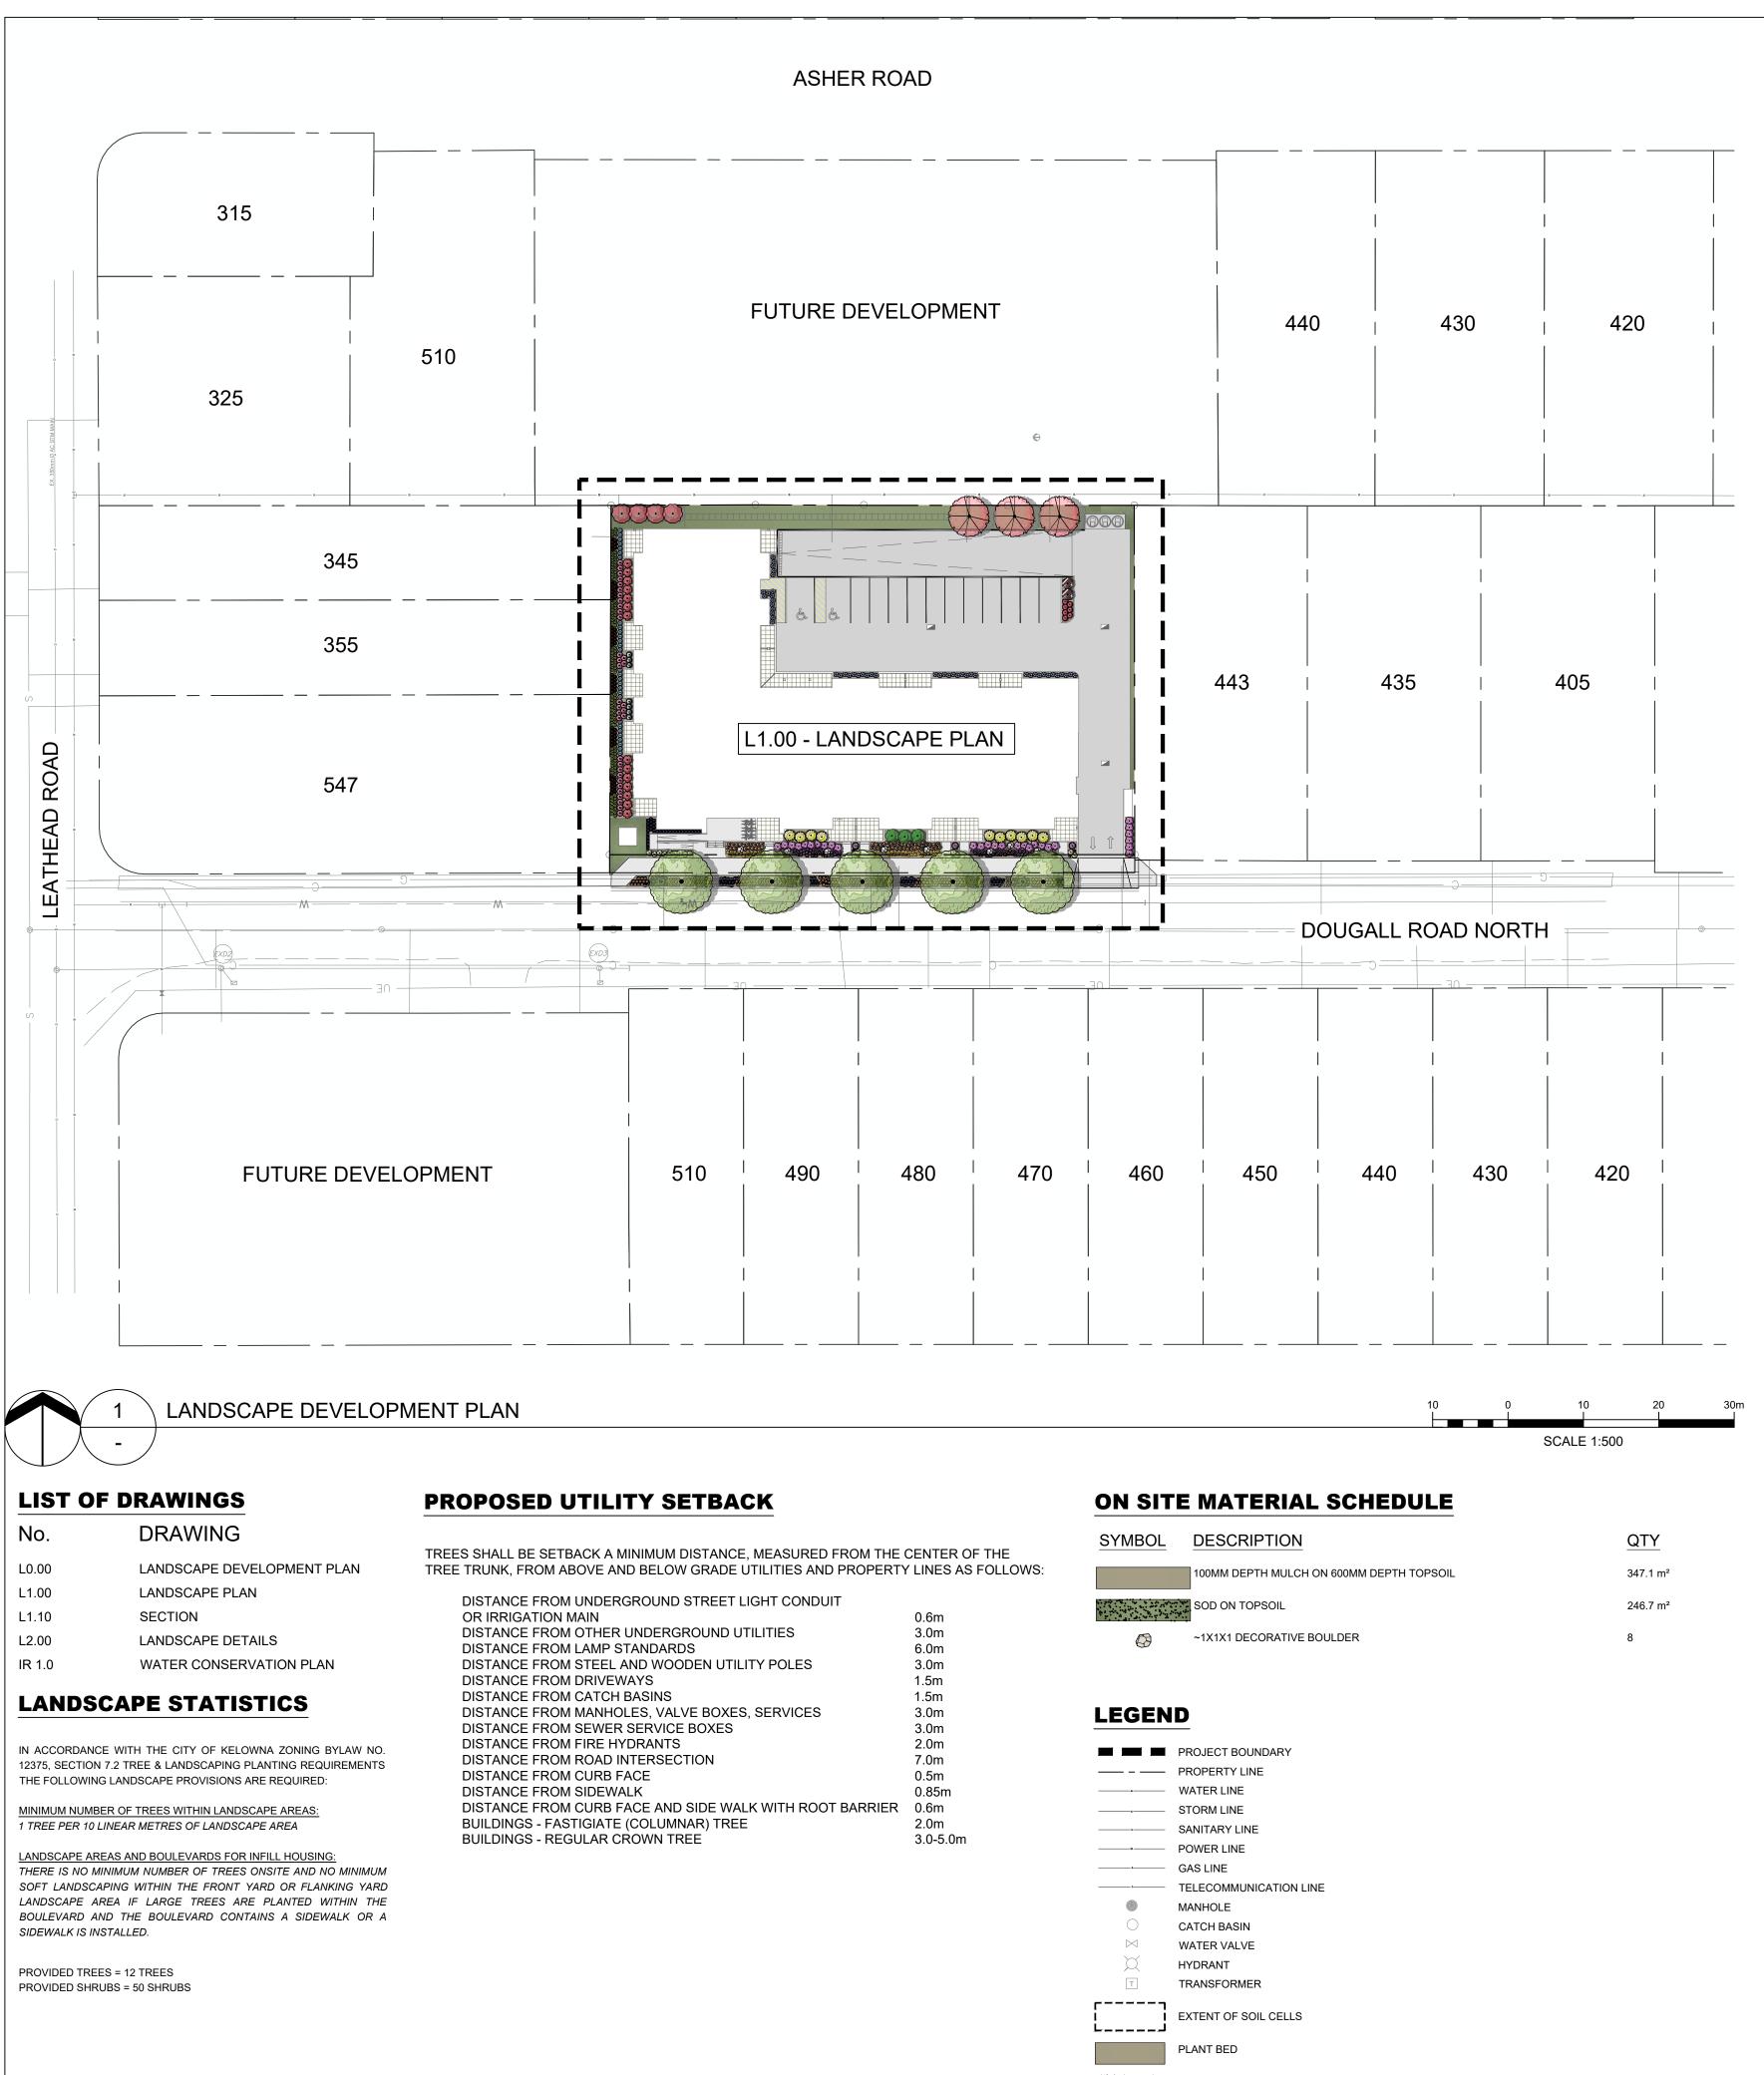
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465-495 DOUGALL ROAD

RENDERINGS

REVISION NO., DATE AND DESCRIPTION



SYMBOL	DESCRIPTION	QTY
	100MM DEPTH MULCH ON 600MM DEPTH TOPSOIL	347.1 m²
	SOD ON TOPSOIL	246.7 m²

L	E	G	Ε	N	D
		_			

	<u> </u>
	PROJECT BOUNDARY
	PROPERTY LINE
z	WATER LINE
	STORM LINE
ī	SANITARY LINE
m	POWER LINE
ı	GAS LINE
	TELECOMMUNICATION LINE
۲	MANHOLE
\bigcirc	CATCH BASIN
\bowtie	WATER VALVE
X	HYDRANT
Т	TRANSFORMER
	EXTENT OF SOIL CELLS
	PLANT BED
	SOD
	PATIOS
	ASPHALT ROAD
	CONCRETE WALK

DECORATIVE BOULDER

LANDSCAPE NOTES

1. GENERAL:

- a. ALL WORK TO CONFORM WITH CANADIAN LANDSCAPE STANDARDS CURRENT EDITION AND CITY OF KELOWNA DEVELOPMENT GUIDELINES AND STANDARD SPECIFICATIONS: LANDSCAPE CONSTRUCTION (CDGSS) REFER TO CIVIL ENGINEERING DRAWINGS FOR ALL GRADING UTILITY INFORMATION
- CONTRACTOR IS TO VISIT THE SITE TO CONFIRM ALL SITE CONDITIONS PRIOR TO MOBILIZING FOR CONSTRUCTION. ANY DISCREPANCIES ARE TO BE
- REPORTED TO THE CONSULTANT FOR CLARIFICATION LIMITS OF THE WORK ARE TO BE CLEARLY UNDERSTOOD BY THE CONTRACTOR PRIOR TO ANY WORK TAKING PLACE ON SITE. THE CONTRACTOR IS TO CONTACT THE CONSULTANT FOR CLARIFICATION IF REQUIRED
- THE CONTRACTOR IS TO VERIFY ALL DIMENSIONS AND REPORT ANY DISCREPANCIES TO THE CONSULTANT FOR FURTHER DIRECTION LAYOUT IS TO BE APPROVED BY THE CONSULTANT PRIOR TO THE START OF CONSTRUCTION
- ALL MEASUREMENTS ARE IN METRES UNLESS OTHERWISE NOTED ANY AMBIGUITY IN THIS DRAWING OR ACCOMPANYING DETAILS IS TO BE REPORTED TO THE CONSULTANT FOR CLARIFICATION. THE CONTRACTOR IS NOT TO PROCEED IN UNCERTAINTY

2. PERMITS AND STANDARDS:

THE CONTRACTOR IS TO COORDINATE WITH THE CONSULTANT TO ENSURE ALL MILESTONE INSPECTIONS ARE CONDUCTED AS PRESCRIBED IN CDGSS ALL ANCILLARY WORK NORMALLY ASSOCIATED WITH THIS TYPE OF b. CONSTRUCTION SHALL BE DEEMED TO BE PART OF THE CONTRACT

3. SITE WORK:

- CONTRACTOR TO SECURE PERMITS AS REQUIRED BY THE CITY OF KELOWNA a. FOR ANY HOARDING OR CONSTRUCTION TAKING PLACE ON ROAD RIGHT OF WAY
- ALL CONSTRUCTION ON-SITE MUST OCCUR CONCURRENTLY WITH EROSION b. CONTROL AND PROTECTION MEASURES TO PREVENT THE POLLUTION, DEGRADATION, OR SILTATION OF NATURAL AREAS, INCLUDING VEGETATION AND WATER COURSES. THIS INCLUDES THE PROVISION OF TEMPORARY FENCING PRIOR TO AND DURING CONSTRUCTION ALL EXPENSES OCCURRED FOR PERMITTING ARE TO BE BORNE BY THE C.
- CONTRACTOR THE CONTRACTOR SHALL SUPPLY ALL MATERIALS IN QUANTITIES SUFFICIENT TO COMPLETE THE WORK SHOWN ON THE DRAWINGS. ANY DISCREPANCIES IN
- QUANTITIES SHALL BE REPORTED TO THE CONSULTANT IMMEDIATELY FOR CLARIFICATION
- NO SUBSTITUTIONS OF MATERIALS, PRODUCTS, OR QUANTITIES SHALL BE PERMITTED WITHOUT PRIOR CONSENT OF THE CONSULTANT THE CONTRACTOR IS RESPONSIBLE FOR THE HAULING OF ALL EXCESS MATERIALS OFF THE SITE TO A LOCATION DESIGNATED BY THE CONSULTANT OR THE OWNERS REPRESENTATIVE
- THE CONTRACTOR IS RESPONSIBLE FOR GENERAL SITE CLEAN-UP THE CONTRACTOR IS RESPONSIBLE FOR ANY DAMAGE TO LANDSCAPED AREAS AND MUST MAKE ALL NECESSARY RESTORATIONS AND REPAIRS.

TOPSOIL: 4.

- ALL TOPSOIL MUST CONFORM TO THE CITY OF KELOWNA TOPSOIL a. REQUIREMENTS
- TOPSOIL TO BE USED TO SPECIFIED DEPTHS FOR ALL GRASSED AREAS, TREE b. PLANTING, SHRUB BEDS, PERENNIAL AND ANNUAL PLANTING, UNLESS

PLANT SCHEDULE

			_
SYMBOL	CODE	QTY	COMMON NAME
TREES			
	PP2	3	PERSIAN IRONWOOD
	SF	4	PYRAMIDAL MOUNTAIN ASH
\bigcirc	ТН	5	HARVEST GOLD LINDEN
SHRUBS			
\bigcirc	Bx	7	LO & BEHOLD® BLUE CHIP BUTTERFLY BU
	Cv	28	SNOWBRUSH
\bigcirc	En	3	RUBBER RABBITBRUSH
	PP	2	DWARF MUGO PINE
	Ri	10	KIMBERLY WILD ROSE
PERENNIA	LS		
\bigcirc	AU	90	BEARBERRY
Ô	AD	14	GOATSBEARD
Õ	Cf3	6	BLUE SEDGE
Ó	CL	29	NORTHERN SEA OATS
\bigcirc	DT	142	CRINKLED HAIR GRASS
\bigcirc	Ga	55	BROWN EYED SUSAN
\bigcirc	Hs4	78	BLUE OAT GRASS
\bigcirc	HR	62	RUBY STELLA DAYLILY
	HP	101	PURPLE LEAVED CORAL BELLS
\odot	Hm2	34	AUGUST MOON HOSTA
	Pa6	3	RUSSIAN SAGE
\bigcirc	Pc	7	GIANT SOLOMON'S SEAL
	Sa	137	AUTUMN JOY STONECROP
	SM2	48	MEXICAN FEATHER GRASS
	VB	90	BLUE WOOLLY CREEPING SPEEDWELL
	YG2	58	GOLDEN SWORD YUCCA
\bigcirc	YG	15	SOAPWEED

С

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d.

OTHERWISE NOTED. TOPSOIL SHALL BE OF A NATURAL, FERTILE AGRICULTURAL SOIL OF THE "A" HORIZON LAYER CAPABLE OF SUSTAINING VIGOROUS PLANT GROWTH. IT SHALL BE THE BEST OF QUALITY AND SCREENED.

TOPSOIL SHALL BE FREE OF SUBSOIL, CLAY LUMPS, STONES, LIVE PLANTS AND OTHER ROOTS, STICKS OR OTHER EXTRANEOUS MATTER OVER 50mm IN DIAMETER. TOPSOIL FOR ALL SOD AREAS SHALL CONFORM TO THE FOLLOWING:

 ORGANIC MATTER 5 - 10% BY DRY MASS

TOXIC CHEMICALS

- ELECTRICAL CONDUCTIVITY MAX. 2.0 Ohms PER cm²
- pH VALUE
- COMPOSITION
- TOPSOIL FOR ALL PLANTING AREAS SHALL CONFORM TO THE FOLLOWING

15-30%

NONE

6.0 - 7.5

SAND 35-60%, SILT 15-50%, CLAY

CLAY 0-25%

 ORGANIC MATTER 10 - 15% BY DRY MASS TOXIC CHEMICALS NONE ELECTRICAL CONDUCTIVITY MAX. 4.0 Ohms PER cm² pH VALUE 6.0 - 7.5 COMPOSITION SAND 50-75%, SILT 10-20%,

5. PLANTING:

- ALL PLANT MATERIAL AND WORKMANSHIP IS TO CONFORM TO CANADIAN NURSERY STOCK STANDARDS IN ITS LATEST EDITION
- ALL PLANT MATERIAL IS TO BE NURSERY GROWN STOCK AND SHALL MEET OR EXCEED THE SPECIFICATIONS OF THE CANADIAN NURSERY TRADES ASSOCIATED (CNTA) FOR SIZE, HEIGHT SPREAD, GRADING, QUALITY, AND METHOD OF CULTIVATION
- ALL PLANTING BEDS TO INCLUDE 100mm DEPTH CONIFEROUS WOOD CHIP MULCH (OR APPROVED EQUAL)
- ALL TREE STAKES ARE TO BE REMOVED AT THE END OF THE ONE YEAR MAINTENANCE AND GUARANTEE PERIOD.

6. SOD NOTES:

- CERTIFIED NO. 1 CULTIVATED TURF SOD WITH STRONG FIBROUS ROOT SYSTEM, THICK AND HEALTHY GROWTH AND DELIVERED 24 HOURS FROM THE TIME OF CUTTING. SO SHOWING SIGNS OF DETERIORATION DUE TO AGE OR LACK OF MOISTURE WILL BE REJECTED. SOD MUST BE FREE OF STONES, BURNS, DRY OR BARE SPOTS, TEARS AND DELIVERED MOIST, CUT IN STRIPS OF UNIFORM WIDTH AND THICKNESS AND OF THE FOLLOWING MIX OR APPROVED EQUAL
- SOD LAYING IS TO OCCUR BETWEEN MAY 1ST SEPT. 30TH. LAYING OF SOD b. OUTSIDE THE RECOMMENDED SEASON WILL REQUIRE CONSULTANT APPROVAL PRIOR TO START OF WORK C.
- PREPARATION, INSTALLATION, FERTILIZATION, WARRANTY AND MAINTENANCE OF SOD IS TO BE IN ACCORDANCE WITH (CDGSS) CERTIFIED CANADA NO. 1 MIXTURE, FREE OF DISEASE, WEED SEEDS, OR
- FOREIGN MATTER. MINIMUM GERMINATION OF 75%, MINIMUM PURITY OF 97% AND CONFORMING TO THE MIXES BELOW OR APPROVED ALTERNATIVES ALL AREAS TO RECEIVE SOD ARE TO HAVE TOPSOIL TO A DEPTH OF 130mm е

	BOTANICAL NAME	<u>SIZE</u>	REMARKS
	PARROTIA PERSICA	60MM CAL.	(MEDIUM) - B&B
	SORBUS AUCUPARIA `FASTIGIATA`	60MM CAL.	(SMALL) - B&B
	TILIA CORDATA X MONGOLICA `HARVEST GOLD`	80MM CAL.	(LARGE) - B&B
BUSH	BUDDLEJA X `BLUE CHIP`	#5 POT	600MM HT.
	CEANOTHUS VELUTINUS	#5 POT	300MM HT.
	ERICAMERIA NAUSEOSA	#5 POT	600MM HT.
	PINUS MUGO 'PUMILIO'	#5 POT	600MM HT.
	ROSA WOODSII 'KIMBERLEY'	#5 POT	600MM HT.
	ARCTOSTAPHYLOS UVA-URSI	#1 POT	
	ARUNCUS DIOICUS	#2 POT	
	CAREX FLACCA	#2 POT	
	CHASMANTHIUM LATIFOLIUM	#2 POT	
	DESCHAMPSIA FLEXUOSA 'TETRA GOLD'	#2 POT	
	GAILLARDIA ARISTATA	#1 POT	
	HELICTOTRICHON SEMPERVIRENS	#2 POT	
	HEMEROCALLIS X `RUBY STELLA`	#1 POT	
	HEUCHERA MICRANTHA 'PALACE PURPLE'	#2 POT	
	HOSTA X 'AUGUST MOON'	#2 POT	
	PEROVSKIA ABROTANOIDES	#2 POT	
	POLYGONATUM COMMUTATUM	#2 POT	
	SEDUM ALBOROSEUM 'AUTUMN JOY'	#2 POT	
	STIPA TENUISSIMA	#2 POT	
	VERONICA PECTINATA 'BLUE'	#2 POT	
	YUCCA FILAMENTOSA 'GOLDEN SWORD'	#5 POT	
	YUCCA GLAUCA	#5 POT	
			FOR REVIEW



ARCHITECTURE IN

PHONE:250-448-7801

205-1626 Richter Street

Kelowna, BC VIY 2M3

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| code – (most recent edition) including

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and above ground utilities, wires and

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conduit connections, including (but not

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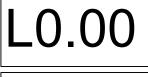
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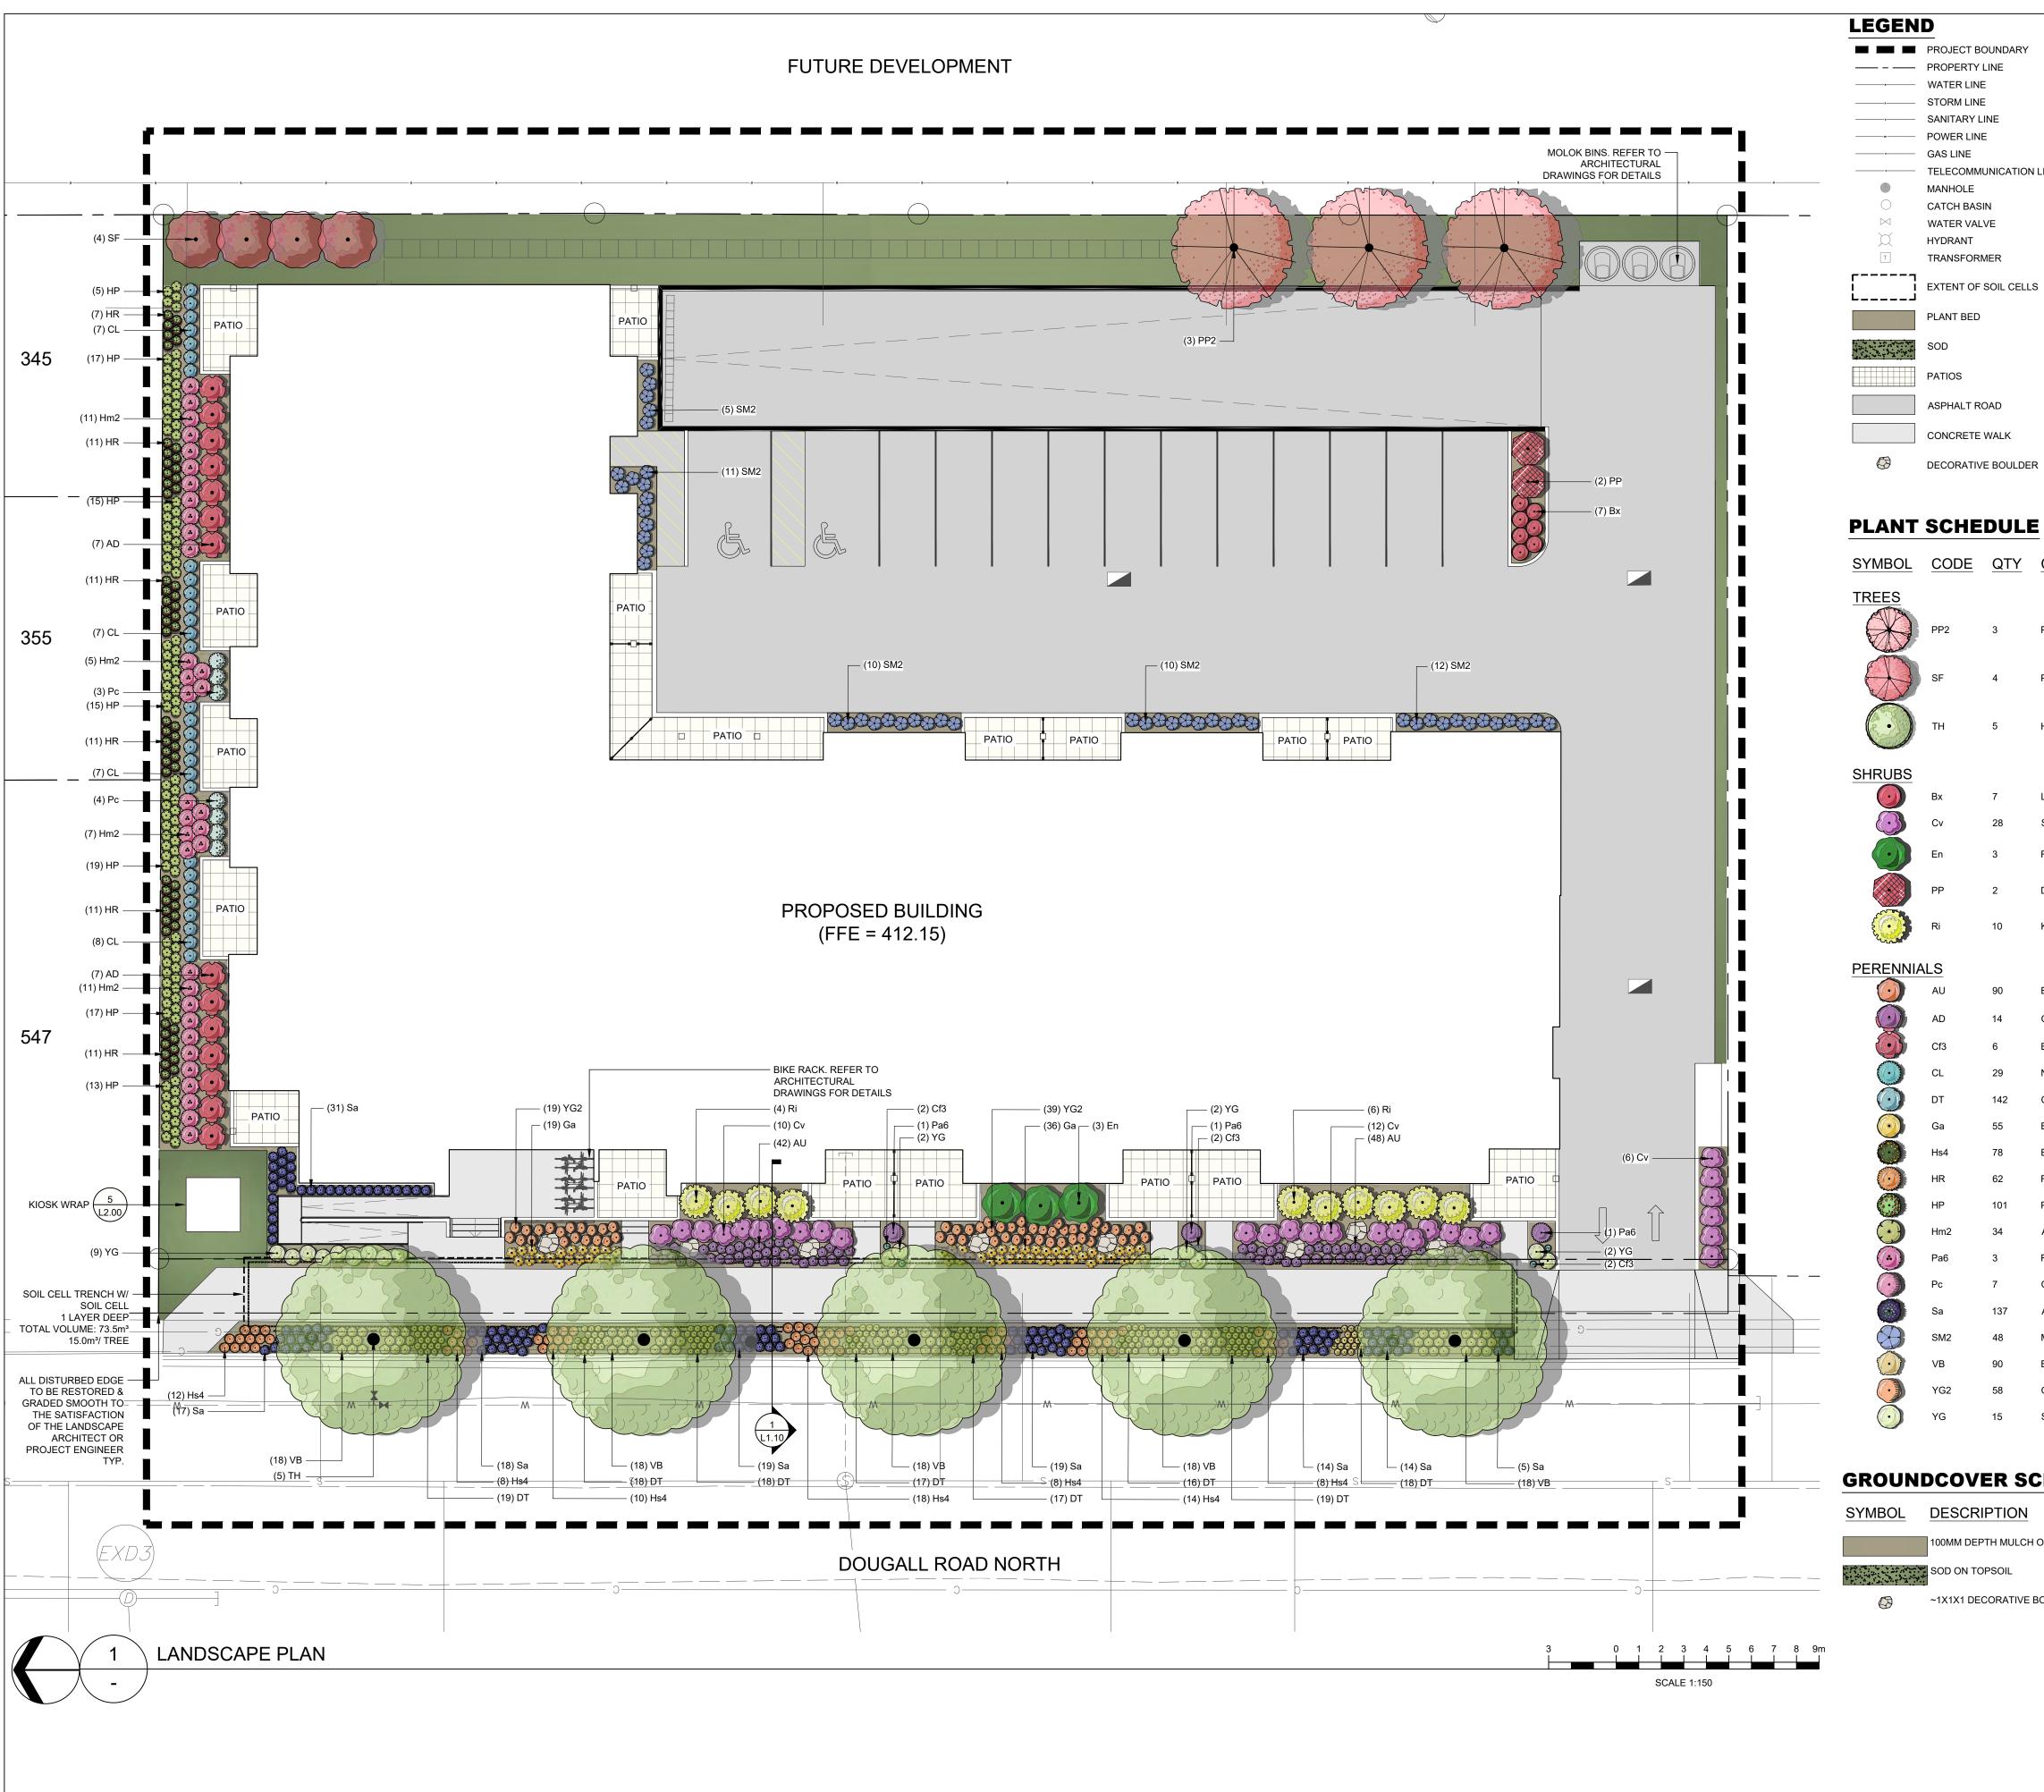
telephone

PLOT DATE 2025/01/17 PROJECT 465-495 DOUGALL ROAD

DRAWING TITLE LANDSCAPE DEVELOPMENT

PLAN DRAWING NO.





TELECOMMUNICATION LINE CATCH BASIN WATER VALVE TRANSFORMER EXTENT OF SOIL CELLS


CONCRETE WALK

DECORATIVE BOULDER

E	<u>QTY</u>	COMMON NAME	BOTANICAL NAME	SIZE	REMARKS
	3	PERSIAN IRONWOOD	PARROTIA PERSICA	60MM CAL.	(MEDIUM) - B&B
	4	PYRAMIDAL MOUNTAIN ASH	SORBUS AUCUPARIA `FASTIGIATA`	60MM CAL.	(SMALL) - B&B
	5	HARVEST GOLD LINDEN	TILIA CORDATA X MONGOLICA `HARVEST GOLD`	80MM CAL.	(LARGE) - B&B
	7	LO & BEHOLD® BLUE CHIP BUTTERFLY BUSH	BUDDLEJA X `BLUE CHIP`	#5 POT	600MM HT.
	28	SNOWBRUSH	CEANOTHUS VELUTINUS	#5 POT	300MM HT.
	2	RUBBER RABBITBRUSH		#5 POT	
	3	RUDDER RADDII DRUSH	ERICAMERIA NAUSEOSA	#3 POT	600MM HT.
	2	DWARF MUGO PINE	PINUS MUGO 'PUMILIO'	#5 POT	600MM HT.
	10	KIMBERLY WILD ROSE	ROSA WOODSII 'KIMBERLEY'	#5 POT	600MM HT.
	90	BEARBERRY	ARCTOSTAPHYLOS UVA-URSI	#1 POT	
	14	GOATSBEARD	ARUNCUS DIOICUS	#2 POT	
	6	BLUE SEDGE	CAREX FLACCA	#2 POT	
	29	NORTHERN SEA OATS	CHASMANTHIUM LATIFOLIUM	#2 POT	
	142	CRINKLED HAIR GRASS	DESCHAMPSIA FLEXUOSA 'TETRA GOLD'	#2 POT	
	55	BROWN EYED SUSAN	GAILLARDIA ARISTATA	#1 POT	
	78	BLUE OAT GRASS	HELICTOTRICHON SEMPERVIRENS	#2 POT	
	62	RUBY STELLA DAYLILY	HEMEROCALLIS X `RUBY STELLA`	#1 POT	
	101	PURPLE LEAVED CORAL BELLS	HEUCHERA MICRANTHA 'PALACE PURPLE'	#2 POT	
	34	AUGUST MOON HOSTA	HOSTA X 'AUGUST MOON'	#2 POT	
	3	RUSSIAN SAGE	PEROVSKIA ABROTANOIDES	#2 POT	
	7	GIANT SOLOMON'S SEAL	POLYGONATUM COMMUTATUM	#2 POT	
	137	AUTUMN JOY STONECROP	SEDUM ALBOROSEUM 'AUTUMN JOY'	#2 POT	
	48	MEXICAN FEATHER GRASS	STIPA TENUISSIMA	#2 POT	
	90	BLUE WOOLLY CREEPING SPEEDWELL	VERONICA PECTINATA 'BLUE'	#2 POT	
	58	GOLDEN SWORD YUCCA	YUCCA FILAMENTOSA 'GOLDEN SWORD'	#5 POT	
	15	SOAPWEED	YUCCA GLAUCA	#5 POT	

GROUNDCOVER SCHEDULE

ESCRIPTION	QTY
0MM DEPTH MULCH ON 600MM DEPTH TOPSOIL	347.1 m ²
DD ON TOPSOIL	246.7 m²
X1X1 DECORATIVE BOULDER	8

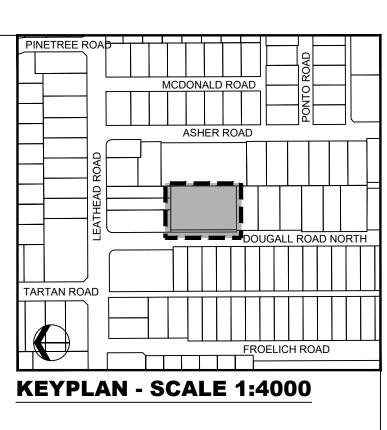



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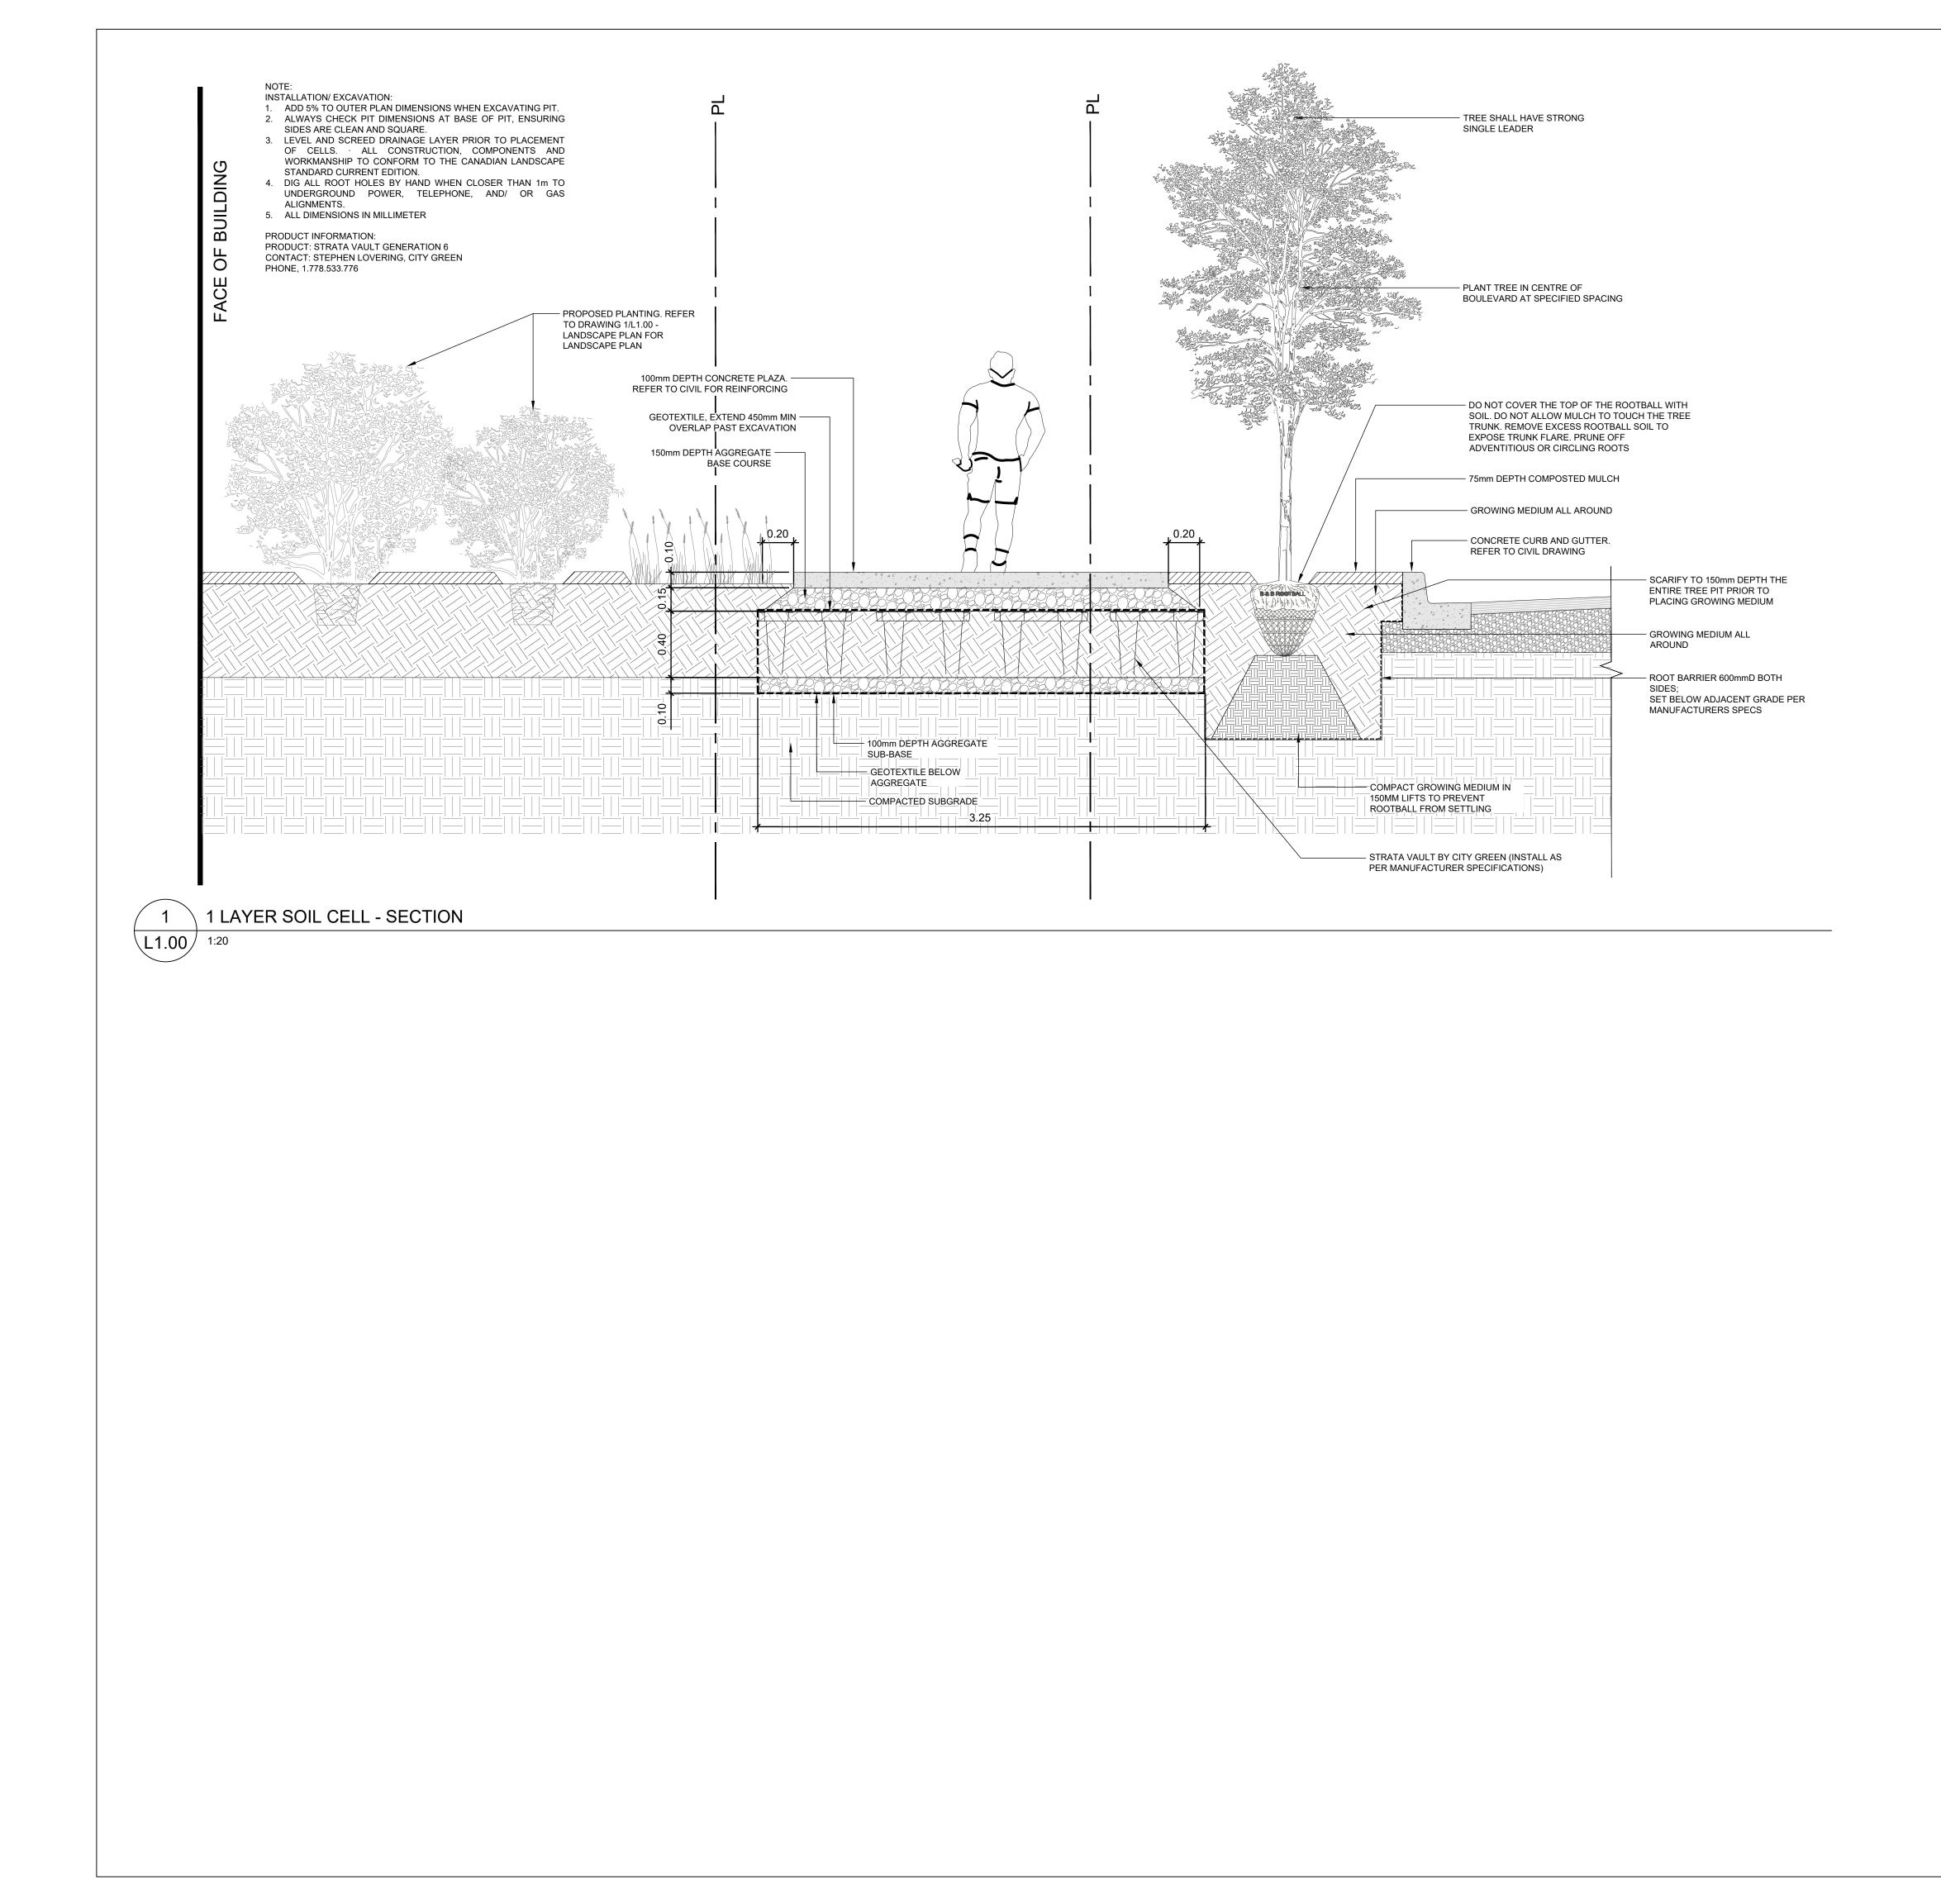


PLOT DATE 2025/01/17 PROJECT 465-495 DOUGALL ROAD DRAWING TITLE


LANDSCAPE PLAN



FOR REVIEW



FOR REVIEW

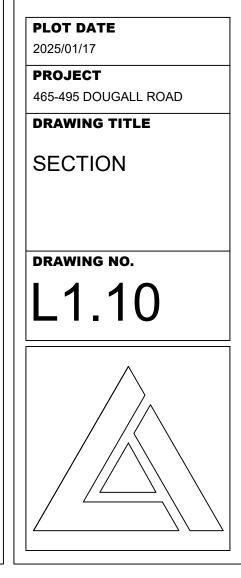



accordance with the current municipality building by-laws and requirements of other local authorities having jurisdiction as well as the british columbia building code — (most recent edition) including all published revisions and addenda. All all published revisions and addenda. All trades shall assume full responsibility for the locations and protection of all under and above ground utilities, wires and conduit connections, including (but not limited to) water, sewer, gas, hydro and telephone telephone.

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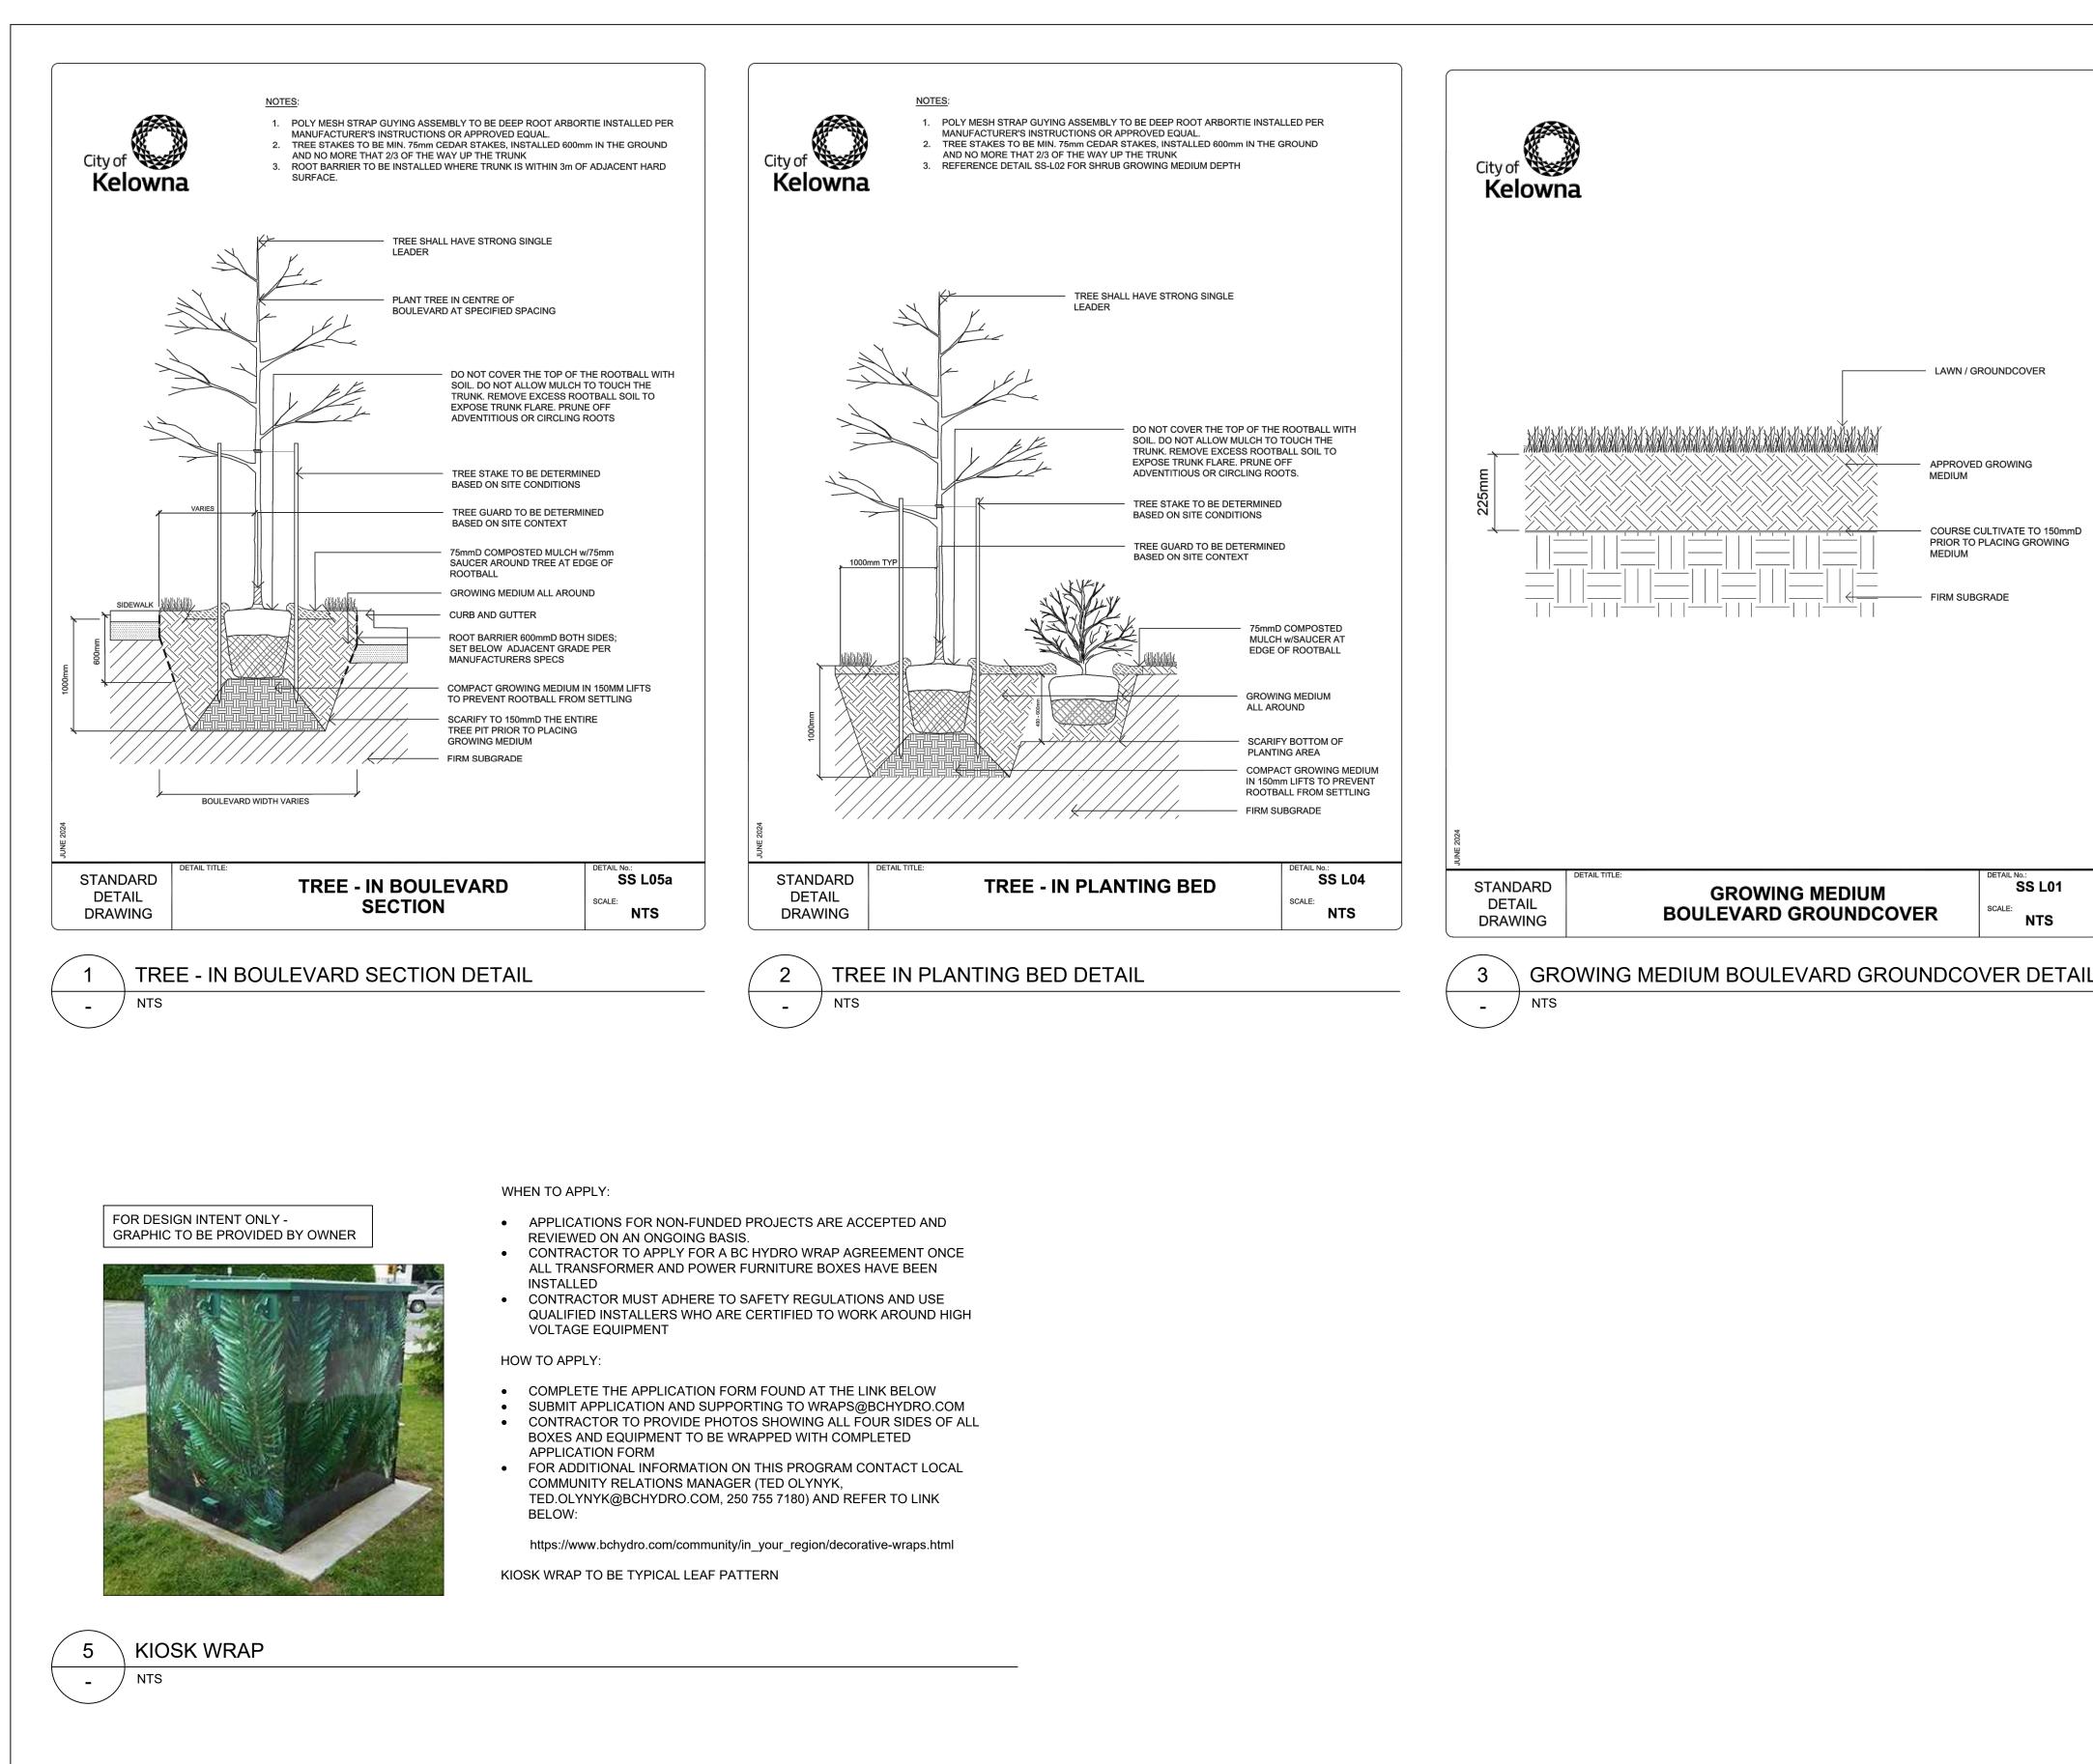
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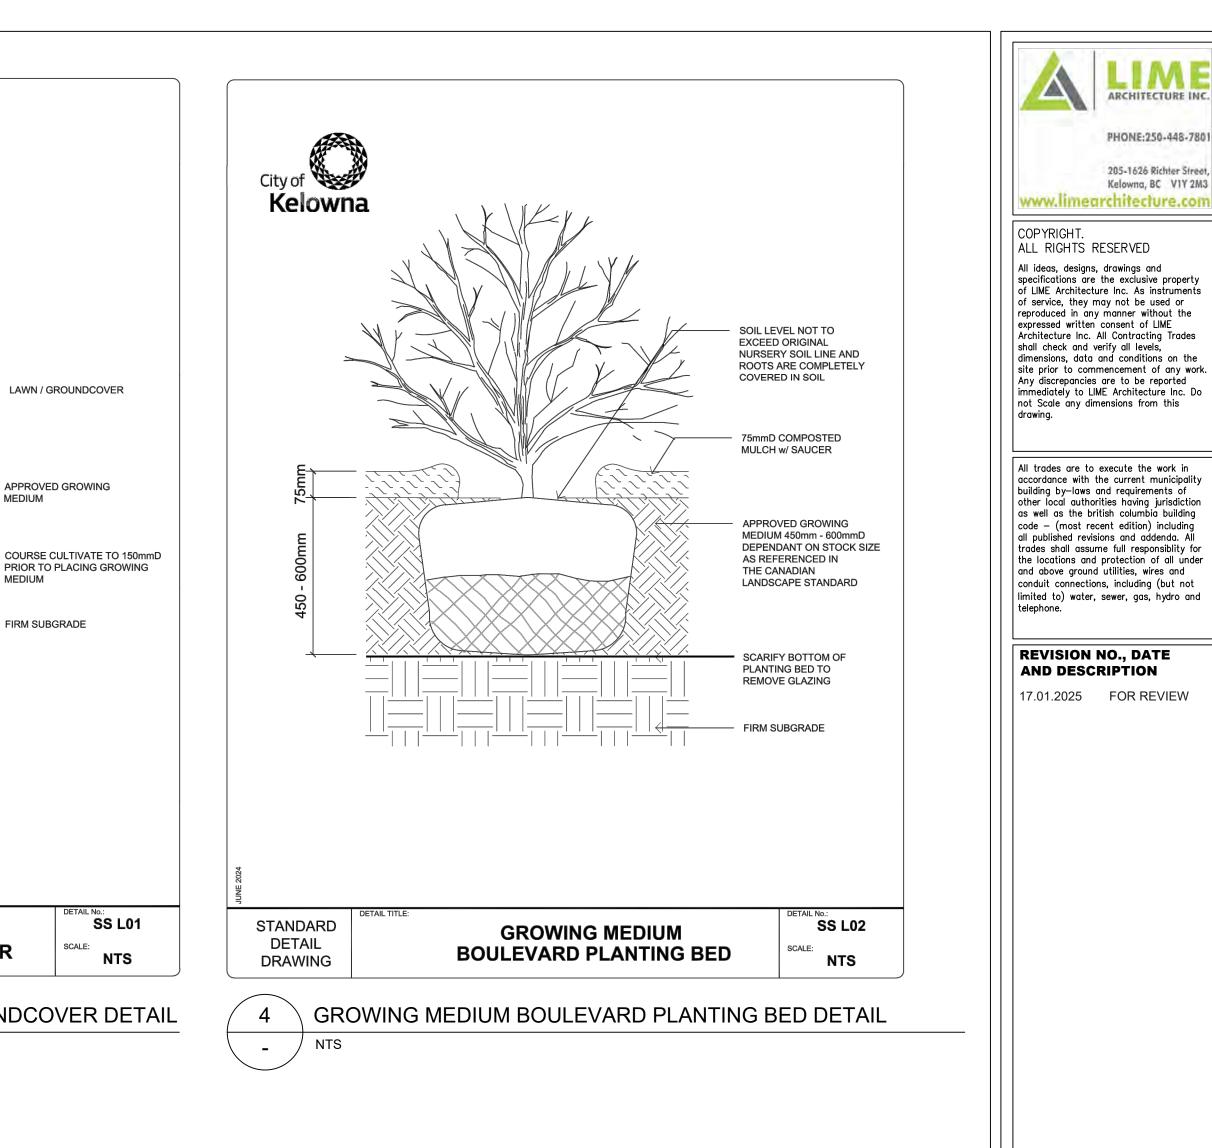
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drawing.

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LAWN / GROUNDCOVER

APPROVED GROWING

PRIOR TO PLACING GROWING

SS L01

NTS

SCALE:


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FIRM SUBGRADE





DRAWING TITLE


LANDSCAPE DETAILS

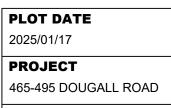

FOR REVIEW

ESTIMATE	PLANT TYPE	IEIVI DEIVIA		AREA	WATER USE				
	SHRUBS	SUBSURFACE IN		365m²	162m³				
	TURF:		IPENSATED SPRAYS	202m ²	231m³				
		TARGET DESIGN F	LOW: 12gpm c/w 25n	1m Ø SERVICE					
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REVISIONS / ISSUED			REVISIONS / ISSUED					
1	JAN 15/25	ISSUED FOR DP						
NO.	DATE	DESCRIPTION	NO.	DATE	DESCRIPTION			

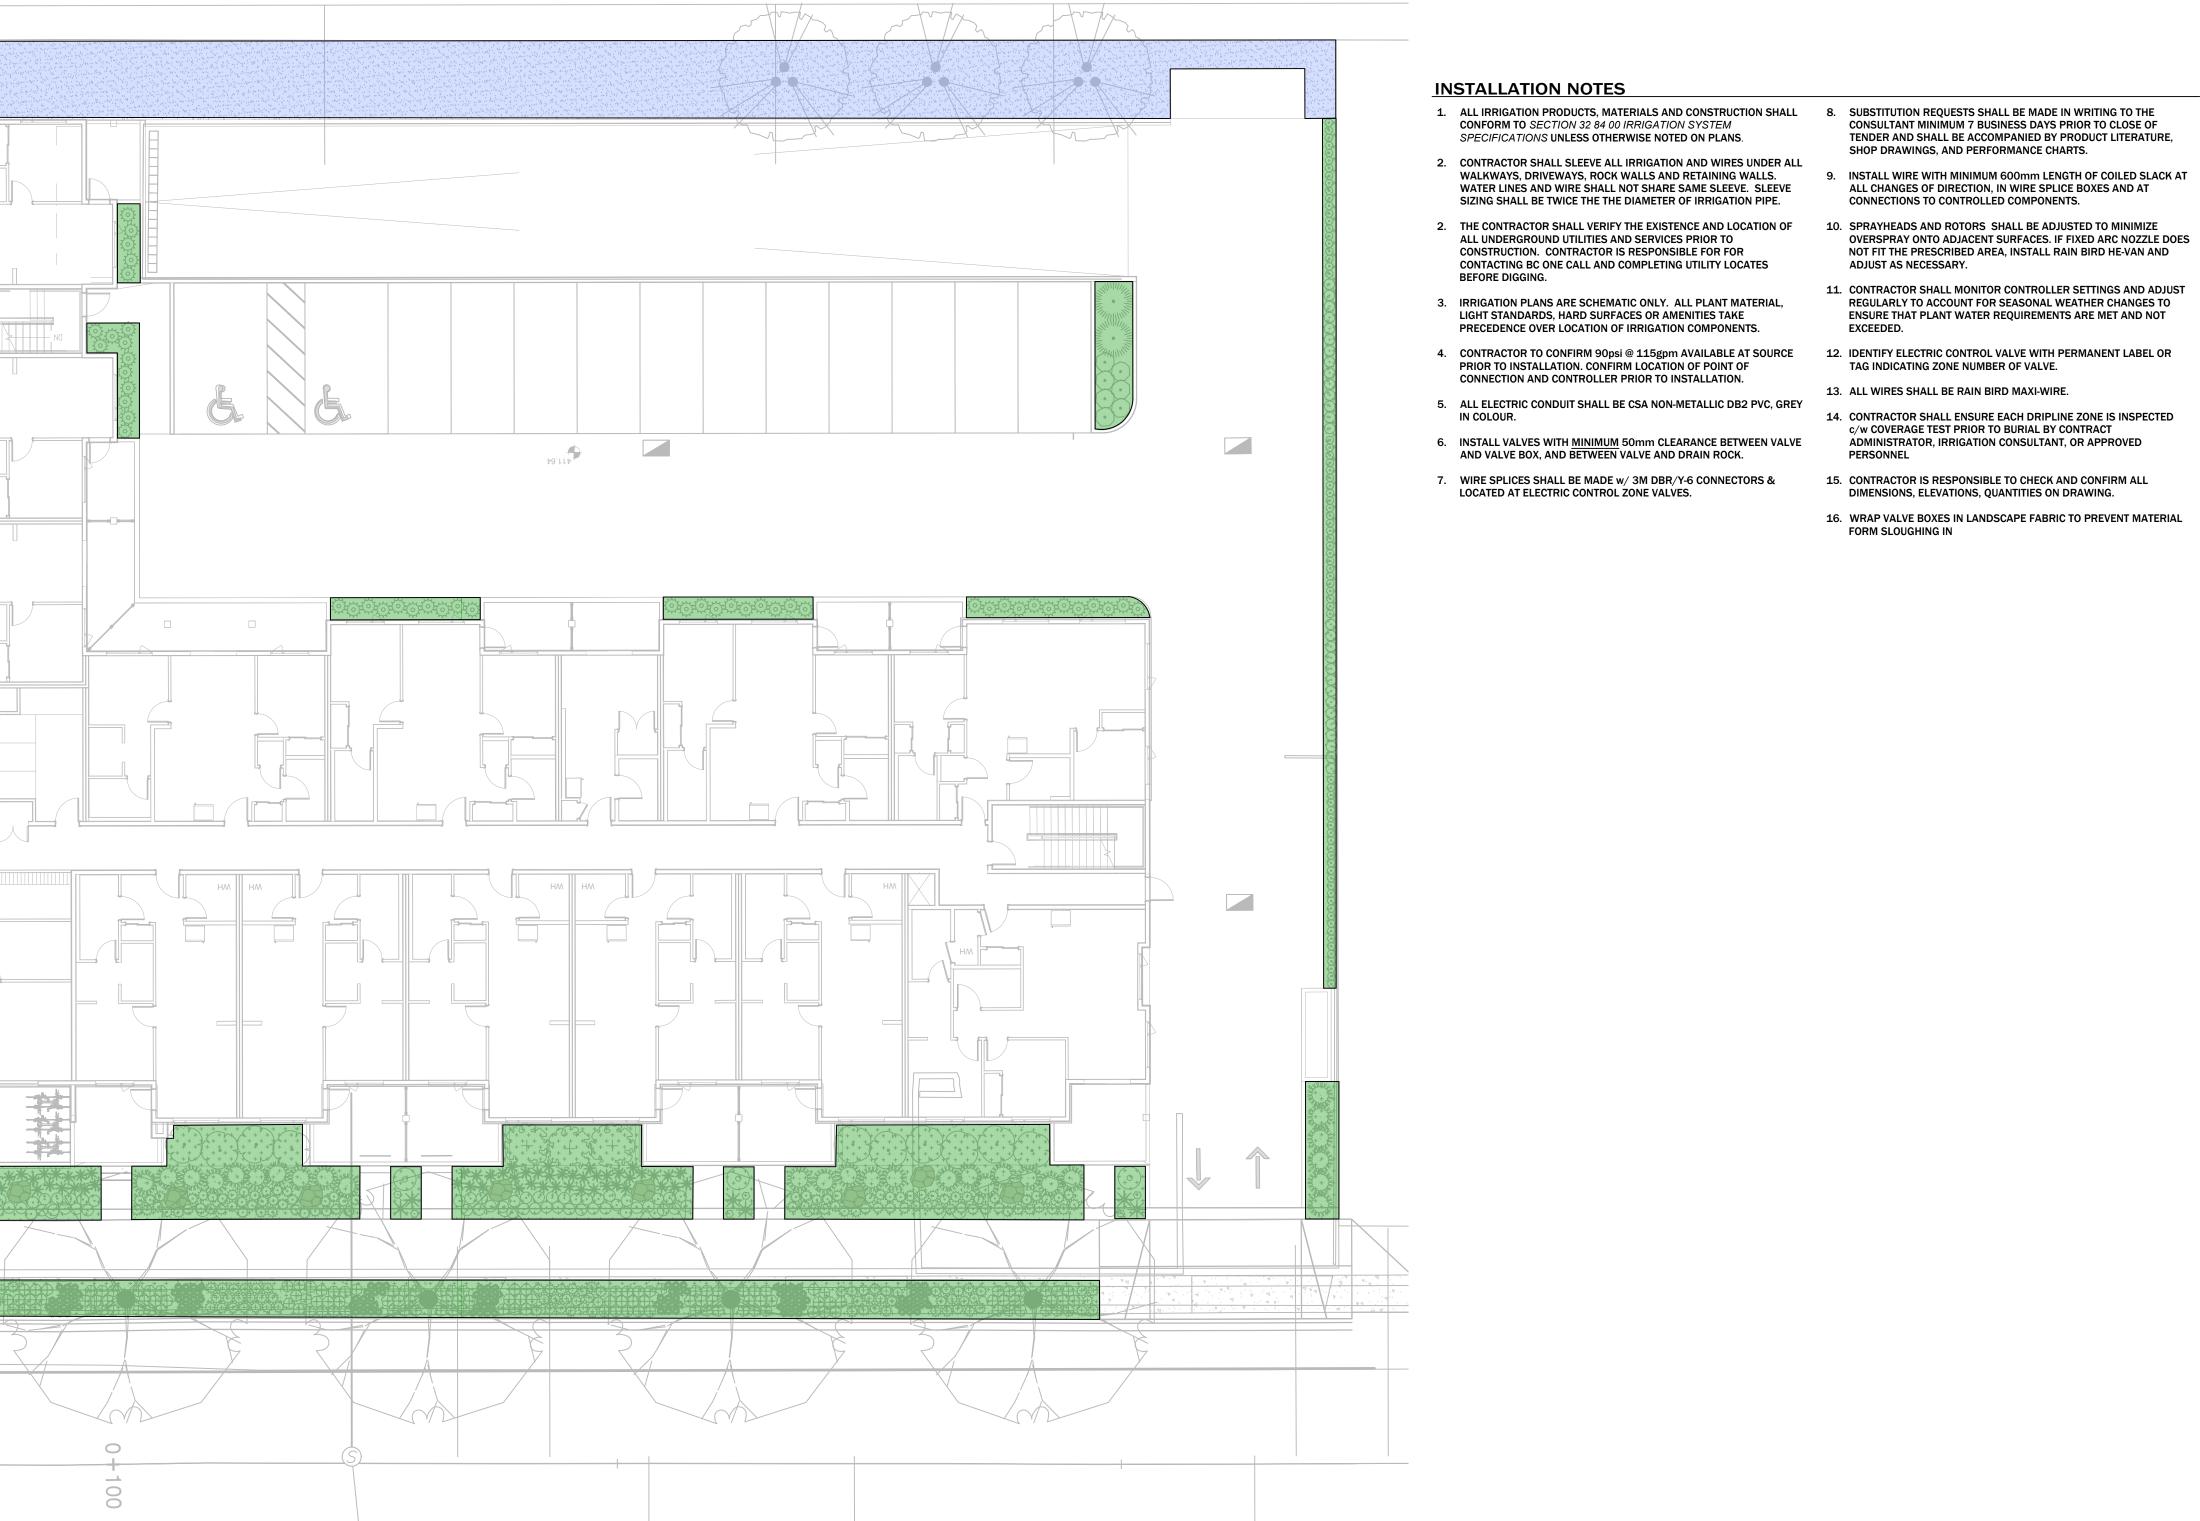

465 DOUGALL ROAD NORTH KELOWNA, BC











DESIGN BY	RH
DRAWN BY	RH
HECKED BY	RH
ROJECT NO.	24-101
SCALE	1:150
	1.100

SHEET NO.

SHEET TITLE WATER CONSERVATION PLAN

IR 1.0



January 23, 2025 File: 682-001 5307 – 47 Street NW Edmonton, AB T6B 3T4 (780) 440-4411

al-terra.com

Troika Management Corp.

302 – 554 Leon Avenue Kelowna, BC V1Y 6J6

(250) 258-0067

Attention: Brad Clifton Senior Development Manager

Re: 465 Dougall Road North – Preliminary Cost Estimate for Bonding

Brad,

Please be advised of the following preliminary cost estimate for bonding of the proposed landscape work shown in the 465 Dougal Road North conceptual landscape plan dated January 17th, 2025:

- On-site Improvements: \$ 80,395.00
- Off-site Improvements: \$133,730.00

The preliminary cost estimate is inclusive of trees, shrubs, perennials, turf, planting beds, soil cells and irrigation.

You will be required to submit a performance bond to the City of Kelowna in the amount of 125% of the preliminary cost estimate. Please do not hesitate to contact me with any questions about the landscape plan.

Yours Truly, AI-Terra Landscape Architecture

William Packolyk, BCSLA Enclosed: 250123 DP Cost Estimate



Getting people where they need to go. Creating places where they want to be.



5307 - 47 Street NW, Edmonton, Alberta T6B 3T4 T: 780.440.4411 al-terra.com

Opinion of Probable Cost Summary Sheet

Date: 2025-01-23 Owner: Troika Management Corporation Project: 465 Dougall Road Location: Kelowna, BC

Schedule Summary

Item	Bid Value
Opinion of Probable Cost - On Site	\$ 80,395.00
Opinion of Probable Cost - Off Site	\$ 133,730.00
Project Subtotal:	\$ 214,125.00
Project Subtotal: Subtotal:	\$ 25,695.00
Grand Total:	\$ 239,820.00

Prepared By: AC

Approved: WP



Opinion of Probable Cost - On Site

Schedule A - Groundcover

ltem	Description	Quantity	Unit	Unit Rate	Extension
.01	Certified #1 Cultivated Sod on 225mm Depth Topsoil	250	m2	\$ 12.00	\$ 3,000.00
.02	Plant Bed - 100mm Depth Mulch on 600mm Depth Topsoil	265	m2	\$ 72.00	\$ 19,080.00
				Subtotal	\$ 22,080.00

Schedule B - Planting

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ltem	Description	Quantity	Unit	Unit Rate	Extension
Trees					
.01	Persian Ironwood - 60mm Caliper	3	Each	\$ 750.00	\$ 2,250.00
.02	Pyramidal Mountain Ash - 60mm Caliper	4	Each	\$ 725.00	\$ 2,900.00
Shrubs					
.03	Lo & Behold Blue Chip Butterfly Bush - 600mm Height	7	Each	\$ 60.00	\$ 420.00
.04	Snowbrush - 300mm Height	28	Each	\$ 65.00	\$ 1,820.00
.05	Rubber Rabbitbrush - 600mm Height	3	Each	\$ 60.00	\$ 180.00
.06	Dwarf Mugo Pine - 600mm Height	2	Each	\$ 75.00	\$ 150.00
.07	Kimberly Wild Rose - 600mm Height	10	Each	\$ 65.00	\$ 650.00
Perennials	s & Grasses				
.08	Bearberry - #1 Pot	90	Each	\$ 25.00	\$ 2,250.00
.09	Goatsbeard - #2 Pot	14	Each	\$ 40.00	\$ 560.00
.10	Blue Sedge - #2 Pot	6	Each	\$ 40.00	\$ 240.00
.11	Northern Sea Oats - #2 Pot	29	Each	\$ 40.00	\$ 1,160.00
.12	Brown Eyed Susan - #1 Pot	55	Each	\$ 25.00	\$ 1,375.00
.13	Ruby Stella Daylily - #1 Pot	62	Each	\$ 25.00	\$ 1,550.00
.14	Purple Leaved Coral Bells - #2 Pot	101	Each	\$ 40.00	\$ 4,040.00
.15	August Moon Hosta - #2 Pot	34	Each	\$ 40.00	\$ 1,360.00
.16	Russian Sage - #2 Pot	3	Each	\$ 40.00	\$ 120.00
.17	Giant Solomon's Seal - #2 Pot	7	Each	\$ 40.00	\$ 280.00
.18	Autumn Joy Stonecrop - #2 Pot	31	Each	\$ 40.00	\$ 1,240.00
.19	Mexican Feather Grass - #2 Pot	48	Each	\$ 40.00	\$ 1,920.00
.20	Golden Sword Yucca - #5 Pot	58	Each	\$ 50.00	\$ 2,900.00
.21	Soapweed - #5 Pot	15	Each	\$ 50.00	\$ 750.00
				Subtotal	\$ 28,115.00

Schedule C - Site Furnishing

ltem	Description	Quantity	Unit	Unit Rate	Extension	
.01	1x1x1 Decorative Boulder	8	Each	\$ 650.00	\$ 5,200).00
				Subtotal:	\$ 5,200).00

Schedule D - Irrigation

Item	Description	Quantity	Unit	Unit Rate	Extension
.01	Irrigation	1	LS	\$ 25,000.00	\$ 25,000.00
			-	Subtotal:	\$ 25,000.00

Project Subtotal:	\$ 80,395.00
HST (12%)	\$ 9,647.40
Grand Total:	\$ 90,042.40



Opinion of Probable Cost - Off Site

Schedule A - Earth Works

ltem	Description	Quantity	Unit	Unit Rate	Extension
.01	Boulevard Excavation (For Tree Trench)	160	m3	\$ 75.00	\$ 12,000.00
.02	Garbage Excavation (For Soil Cells)	75	m3	\$ 55.00	\$ 4,125.00
				Subtotal:	\$ 16,125.00

Schedule B - Groundcover

ltem	Description	Quantity	Unit	Unit Rate	Extension
.01	Soil Cells - 1 Layer Deep	160	m2	\$ 425.00	\$ 68,000.00
.02	Plant Bed - 100mm Depth Mulch on 600mm Depth Topsoil	85	m2	\$ 85.00	\$ 7,225.00
				Subtotal	\$ 75,225.00

Schedule C - Planting

Item	Description	Quantity	Unit	Unit Rate		Extension
Trees						
.01	Harvest Gold Linden - 80mm Caliper	5	Each	\$ 1,900.00	\$	9,500.00
Perennia	s & Grasses					
.02	Crinkled Hair Grass - #2 Pot	142	Each	\$ 40.00	\$	5,680.00
.03	Blue Oat Grass - #2 Pot	78	Each	\$ 40.00	\$	3,120.00
.04	Autumn Joy Stonecrop - #2 Pot	137	Each	\$ 40.00	\$	5,480.00
.05	Blue Woolly Creeping Speedwell - #2 Pot	90	Each	\$ 40.00	\$	3,600.00
				Subtota	: \$	27,380.00

Schedule D - Irrigation

ltem	Description	Quantity	Unit	Unit Rate	Extension
.01	Irrigation	1	LS	\$ 15,000.00	\$ 15,000.00
				Subtotal:	\$ 15,000.00

Project Subtotal:	\$ 133,730.00
HST (12%)	\$ 16,047.60
Grand Total:	\$ 149,777.60